# SITE DEVELOPMENT PLANS for **ABBOTTS RUN** CLUBHOUSE EXPANSION 511 COBBLESTONE DRIVE Wilmington, North Carolina

**OWNER**:

WILMINGTON AR HOUSING LLC 19 N. KING STREET SUITE A LEESBURY, VA 28405

ARCHITECT:

KOT HOSTETLER ARCHITECTS 2906 MARKET STREET, SUITE 101 WILMINGTON, NC 28403

# DESIGNER




Coastal Land Design, PLLC

Civil Engineering / Landscape Architecture Land Planning / Construction Management NCBELS Firm License No: P-0369

P.O.Box 1172 Wilmington, NC 28402 www.cldeng.com

Phone: 910-254-9333 Fax: 910-254-0502

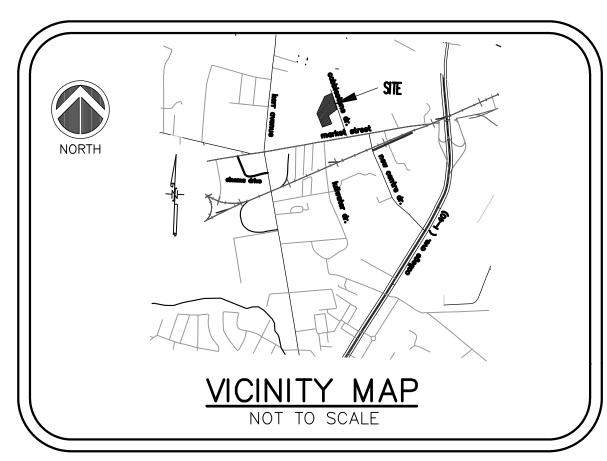

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GENERAL UTILITY NOTE

THE CONTRACTOR IS SPECIFICALLY CAUTIONED THAT THE LOCATION AND/OR ELEVATION OF EXISTING UTILITIES AS SHOWN ON THESE PLANS ARE BASED ON RECORDS FROM THE UTILITY COMPANY AND, WHERE POSSIBLE, MEASUREMENTS TAKEN IN THE FIELD. THE INFORMATION IS NOT TO BE RELIED ON AS BEING EXACT OR COMPLETE. IT SHALL BE THE RESPONSIBILITY OF THE CONTRACTOR TO VERIFY LOCATION OF ALL EXISTING UTILITIES, ANY CONFLICTS SHALL BE BROUGHT TO THE OWNERS AND ENGINEERS ATTENTION IMMEDIATELY

# GENERAL NOTES:

PRIOR TO ANY CLEARING, GRADING OR CONSTRUCTION ACTIVITY, TREE PROTECTION FENCING SHALL BE INSTALLED AROUND PROTECTED TREES OR GROVES OF TREES. NO CONSTRUCTION WORKERS, TOOLS, MATERIALS, OR VEHICLES ARE PERMITTED WITHIN THETREE PROTECTION FENCING. 2. ANY TREES AND/OR AREAS DESIGNATED TO BE PROTECTED MUST BE PROPERLY BARRICADED WITH FENCING AND PROTECTED THROUGHOUT CONSTRUCTION TO INSURE THAT NO CLEARING, GRADING OR STAGING OF MATERIALS WILL OCCUR IN THOSE AREAS. 3. NO EQUIPMENT IS ALLOWED ON SITE UNTIL ALL TREE PROTECTION FENCING AND SILT FENCING IS INSTALLED AND APPROVED. PROTECTIVE FENCING IS TO BE MAINTAINED THROUGHOUT THE DURATION OF THE PROJECT, AND CONTRACTORS SHALL RECEIVE ADEQUATE INSTRUCTION ON TREE PROTECTION METHODS

4. ALL PAVEMENT MARKINGS IN PUBLIC RIGHTS-OF-WAY AND FOR DRIVEWAYS ARE TO BE THERMOPLASTIC AND MEET CITY AND/OR NCDOT STANDARDS 5. ONCE STREETS ARE OPEN TO TRAFFIC, CONTACT TRAFFIC ENGINEERING REGARDING THE INSTALLATION OF TRAFFIC AND STREET NAME SIGNS. PROPOSED STREET NAMES MUST BE APPROVED PRIOR TO INSTALLATION OF STREET NAME SIGNS. 6. TRAFFIC CONTROL DEVICES (INCLUDING SIGNS AND PAVEMENT MARKINGS) IN AREAS OPEN TO PUBLIC TRAFFIC ARE TO MEET MUTCOMANUAL ON UNIFORM TRAFFIC CONTROL DEVICES) STANDARDS.

CONTACT TRAFFIC ENGINEERING AT 910-341-7888 TO ENSURE THAT ALL TRAFFIC SIGNAL FACILITIES AND EQUIPMENT ARE SHOWN ON THE PLAN. CALL TRAFFIC ENGINEERING AT 910-341-7888 FORTY-EIGHT (48) HOURS PRIOR TO ANY EXCAVATION IN THE RIGHT-OF-WAY. TRAFFIC ENGINEERING MUST APPROVE OF PAVEMENT MARKING PRÍOR TO ACTUAL STRIPING

10. ALL PARKING STALL MARKINGS AND LANE ARROWS WITHIN THE PARKING AREAS SHALL BE WHITE.

11. ALL TRAFFIC CONTROL SIGNS AND MARKINGS OFF THE RIGHT-OF-WAY ARE TO BE MAINTAINED BY THE PROPERTY OWNER 12. STOP SIGNS AND STREET SIGNS TO REMAIN IN PLACE DURING CONSTRUCTION.

13. TACTILE WARNING MATS WILL BE INSTALLED ON ALL WHEELCHAIR RAMPS 14. A UTILITY CUT PERMIT IS REQUIRED FOR EACH OPEN CUT OF A CITY STREET

15. ANY BROKEN OR MISSING SIDEWALK OR DRIVEWAY PANEL OR CURBING WILL BE REPLACED.

16. CONTACT TRAFFIC ENGINEERING AT 910-341-7888 TO DISCUSS STREET LIGHTING OPTIONS. 17. WATER AND SEWER SERVICE SHALL MEET CAPE FEAR PUBLIC UTILITY AUTHORITY (CFPUA) DETAILS AND SPECIFICATIONS. 18. PROJECT SHALL COMPLY WITH CFPUA CROSS CONNECTION CONTROL REQUIREMENTS. WATER METER(S) CANNOT BE RELEASED UNTIL ALL

REQUIREMENTS ARE MET AND THE STATE HAS GIVEN THEIR FINAL APPROVAL. CALL 910-343-3910 FOR INFORMATION. 19. IF THE CONTRACTOR DESIRES CFPUA WATER FOR CONSTRUCTION, HE SHALL APPLY IN ADVANCE FOR THIS SERVICE AND MUST PROVIDE A REDUCED PRESSURE ZONE (RPZ) BACKFLOW PREVENTION DEVICE ON THE DEVELOPER'S SIDE OF THE WATER METER BOX 20. ANY IRRIGATION SYSTEM SUPPLIED BY CFPUA WATER SHALL COMPLY WITH THE CFPUA CROSS CONNECTION CONTROL REGULATIONS.CALL 919-343-3910

FOR INFORMATION.

21. ANY IRRIGATION SYSTEM SHALL BE EQUIPPED WITH A RAIN AND FREEZER SENSOR. 22. ANY BACKFLOW PREVENTION DEVICES REQUIRED BY THE CFPUA WILL NEED TO BE ON THE LIST OF APPROVED DEVICES BY USCFCCCHR OR ASSE. 23. CONTRACTOR TO FIELD VERIFY EXISTING WATER AND SEWER SERVICE LOCATIONS, SIZES AND MATERIALS PRIOR TO CONSTRUCTION. ENGINEER TO BE NOTIFIED OF ANY CONFLICTS

24. CONTRACTOR SHALL MAINTAIN ALL-WEATHER ACCESS FOR EMERGENCY VEHICLES AT ALL TIMES DURING CONSTRUCTION. 25. UNDERGROUND FIRE LINE(S) MUST BE PERMITTED AND INSPECTED BY THE WILMINGTON FIRE DEPARTMENT FROM THE PUBLIC RIGHT-OF-WAY TO THE BUILDING. CONTACT THE WILMINGTON FIRE DEPARTMENT DIVISION OF FIRE AND LIFE SAFETY AT 910-341-0696. 26. NO OBSTRUCTIONS ARE PERMITTED IN THE SPACE BETWEEN THIRTY (30) INCHES AND TEN (10) FEET ABOVE THE GROUND WITHIN THE TRIANGULAR SIGHT DISTANCE.

27. CONTACT THE NORTH CAROLINA ONE CALL CENTER AT 1-800-632-4949 PRIOR TO DOING ANY DIGGING, CLEARING, OR GRADING


WILMINGTON NORTH CAROLINA								
Approved Construction Plan								
Name <u>Date</u>								
Plann <u>ing</u>								
Tra <u>ffic</u>								
-ire								


PRELIMINARY DESIGN NOT RELEASED FOR CONSTRUCTION


**ISSUED FOR AGENCY** REVIEW ONLY




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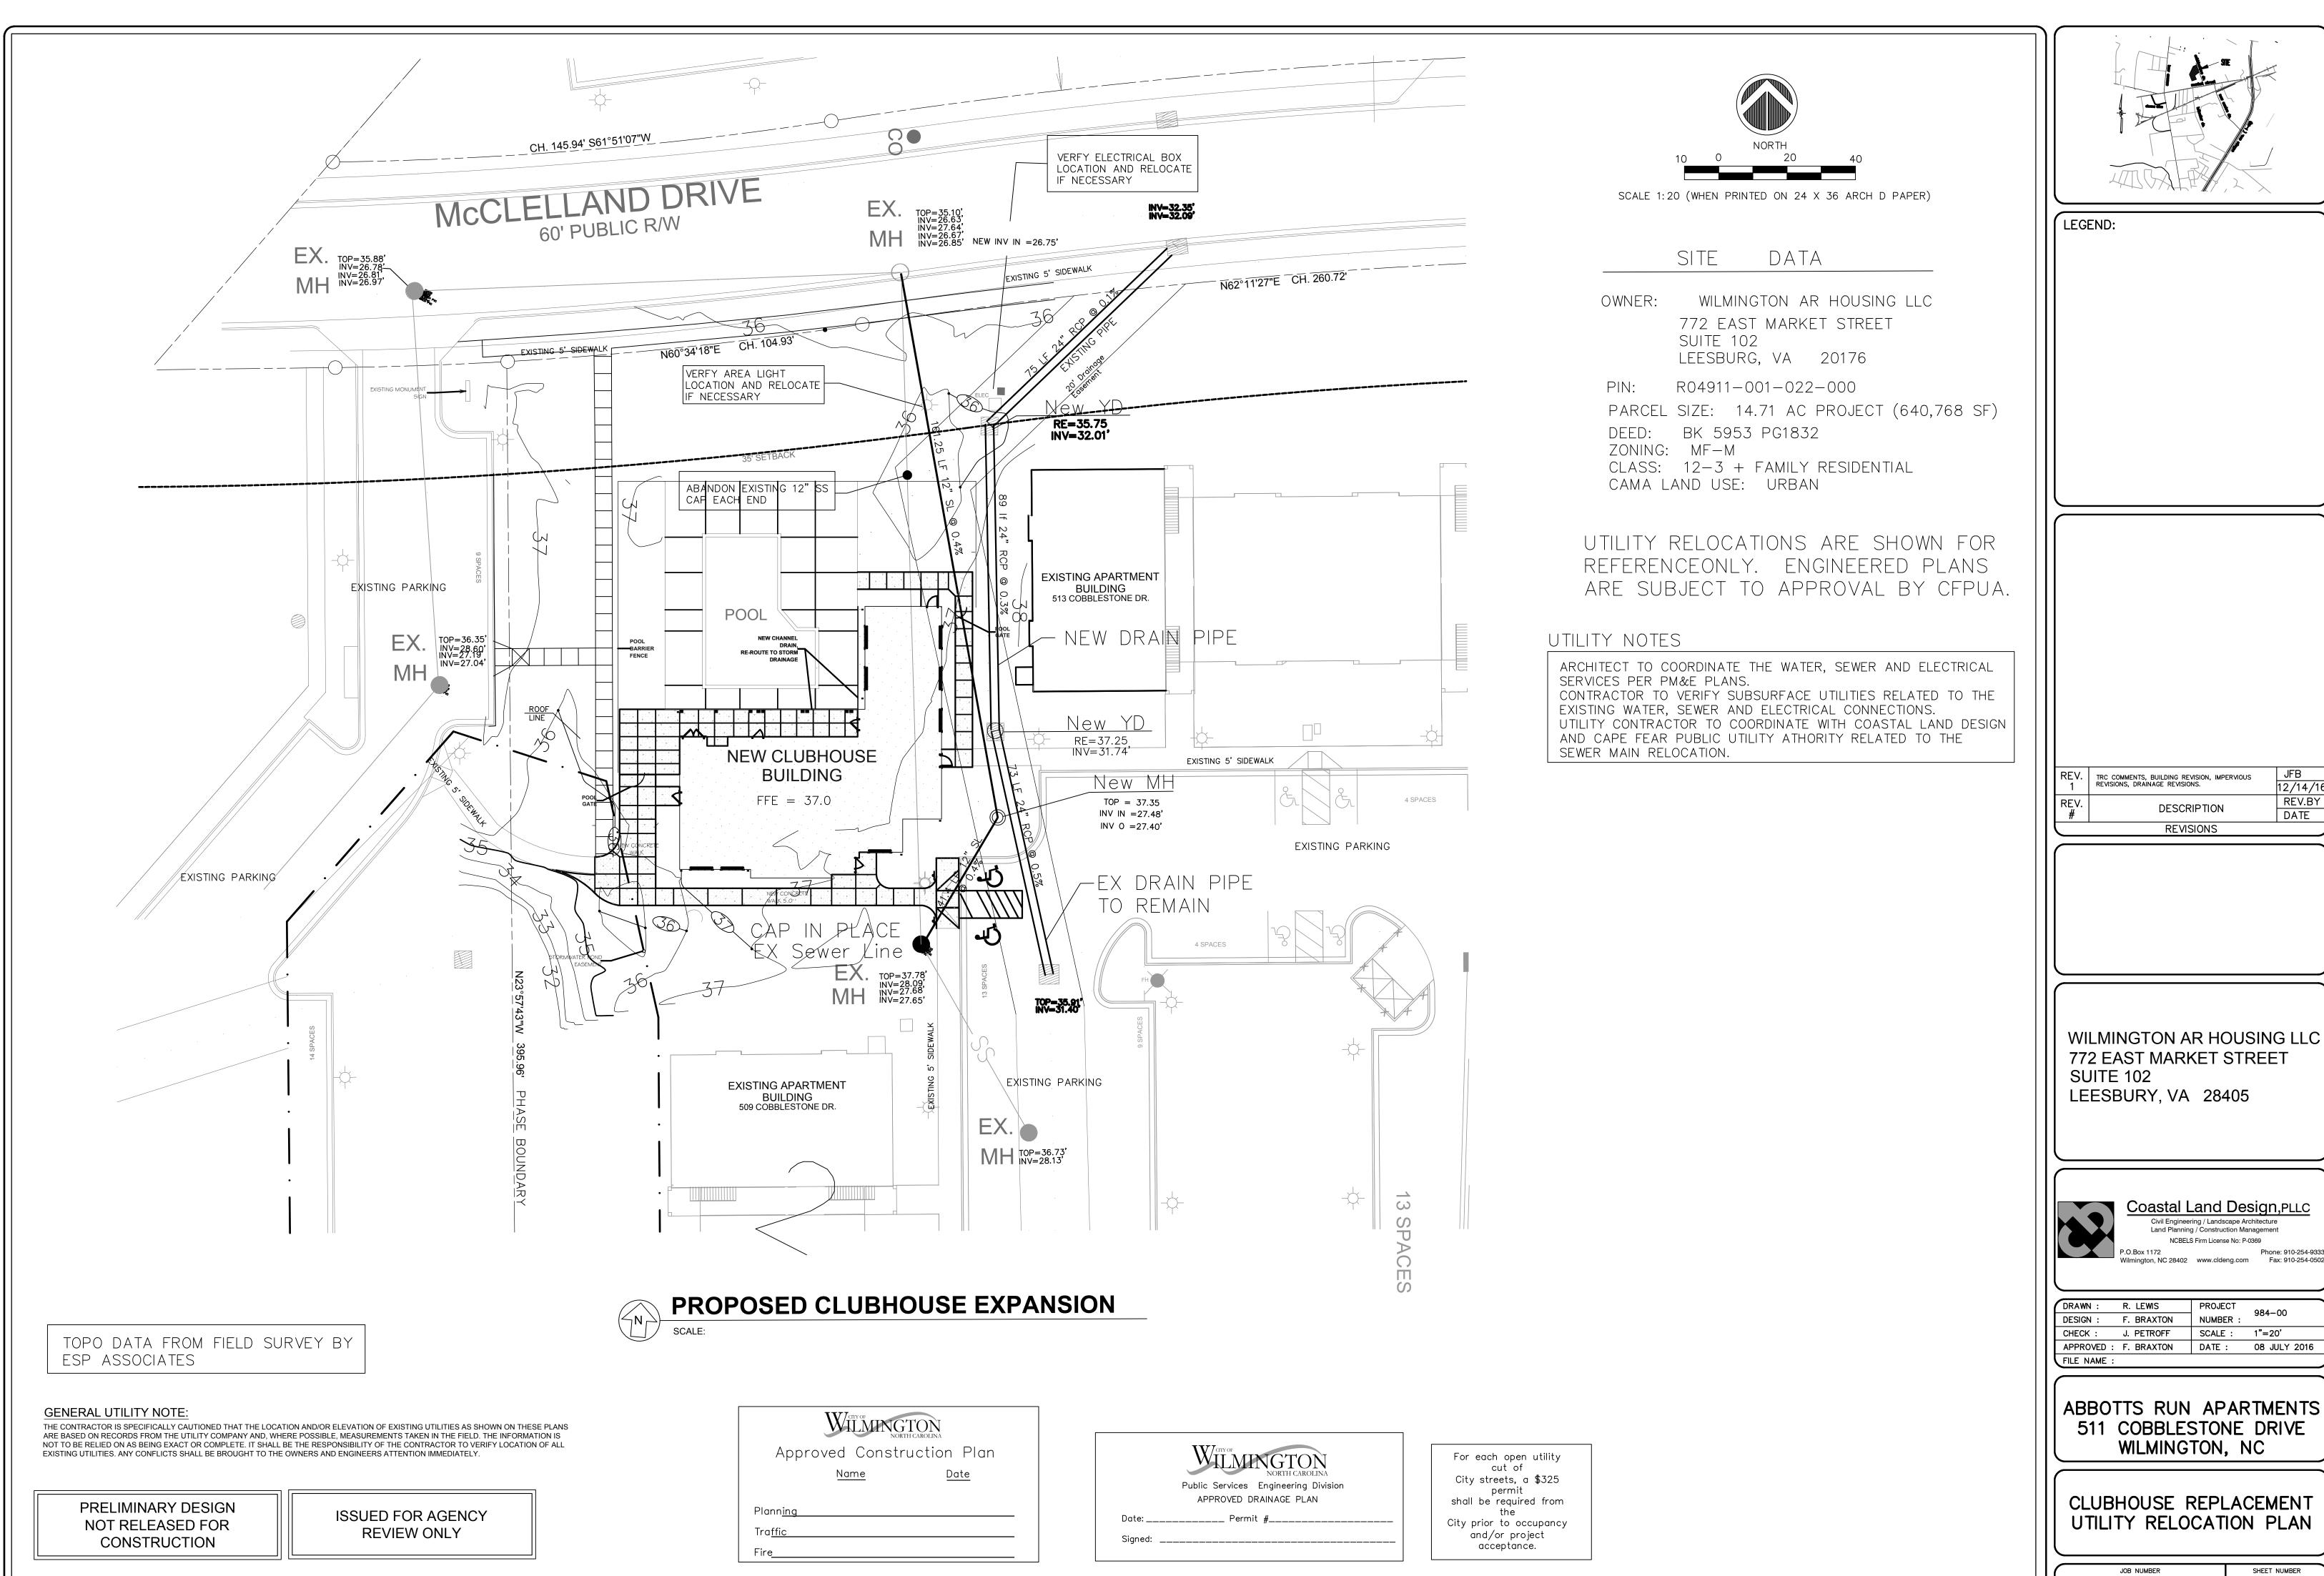


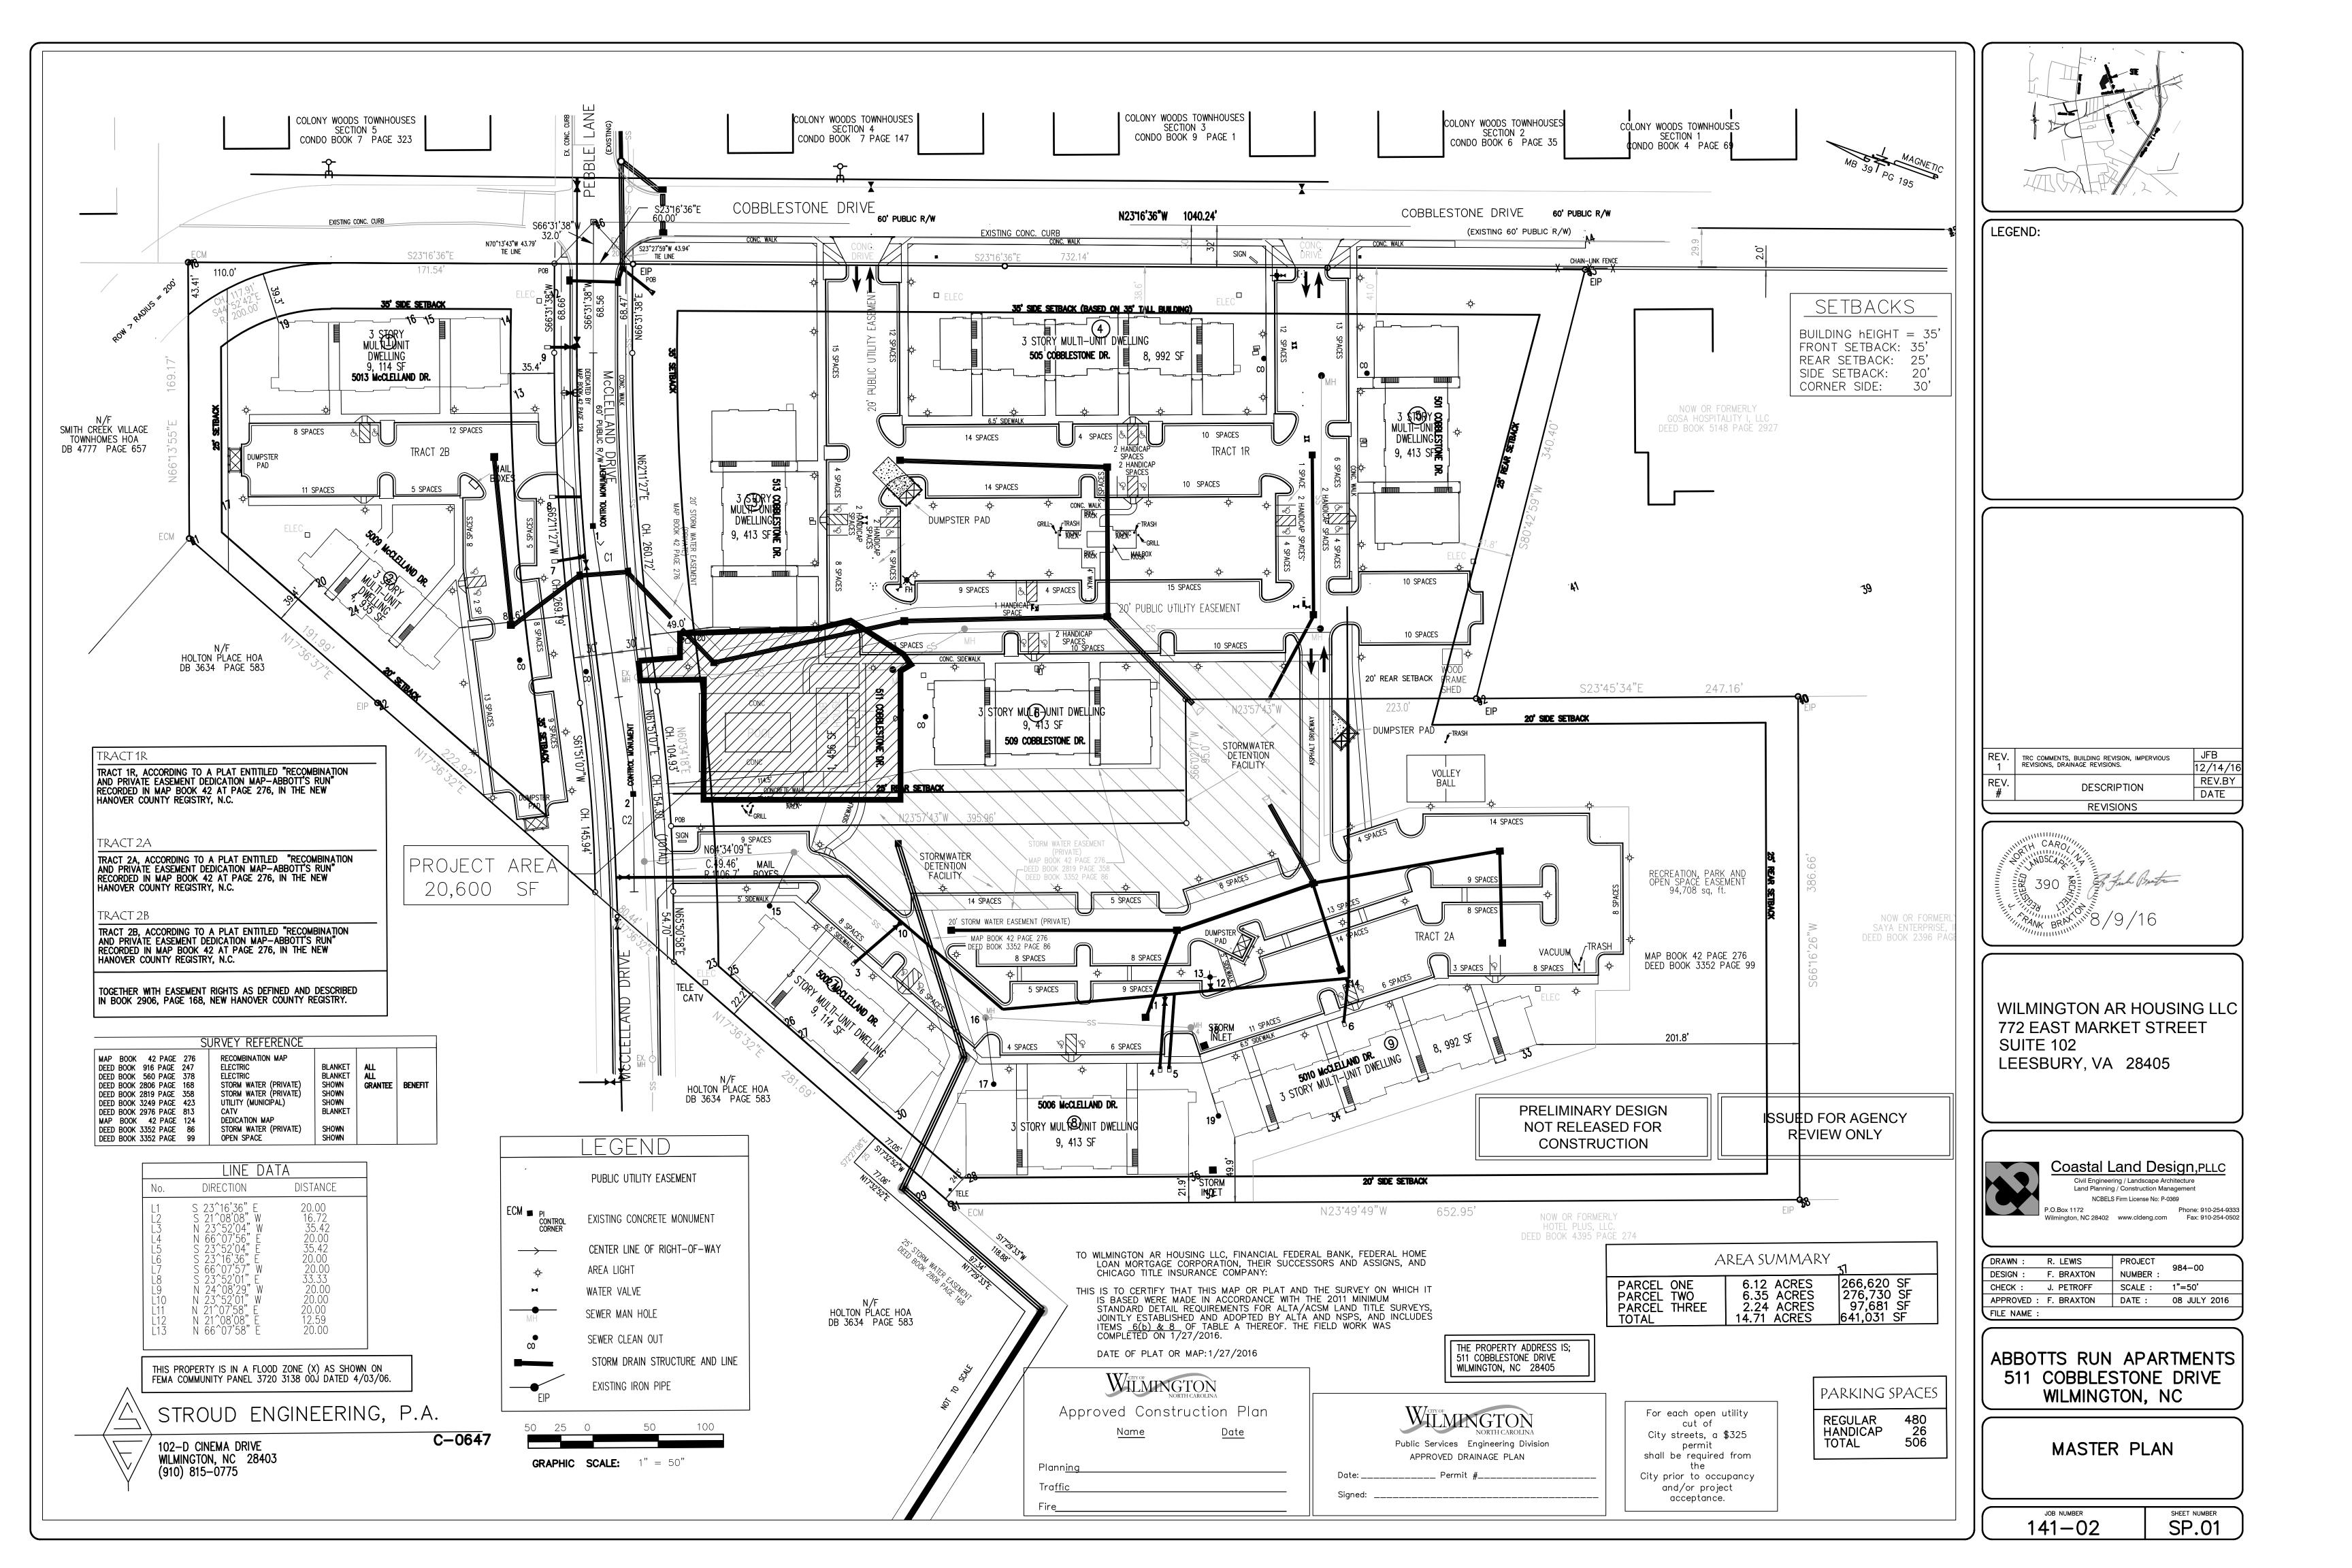

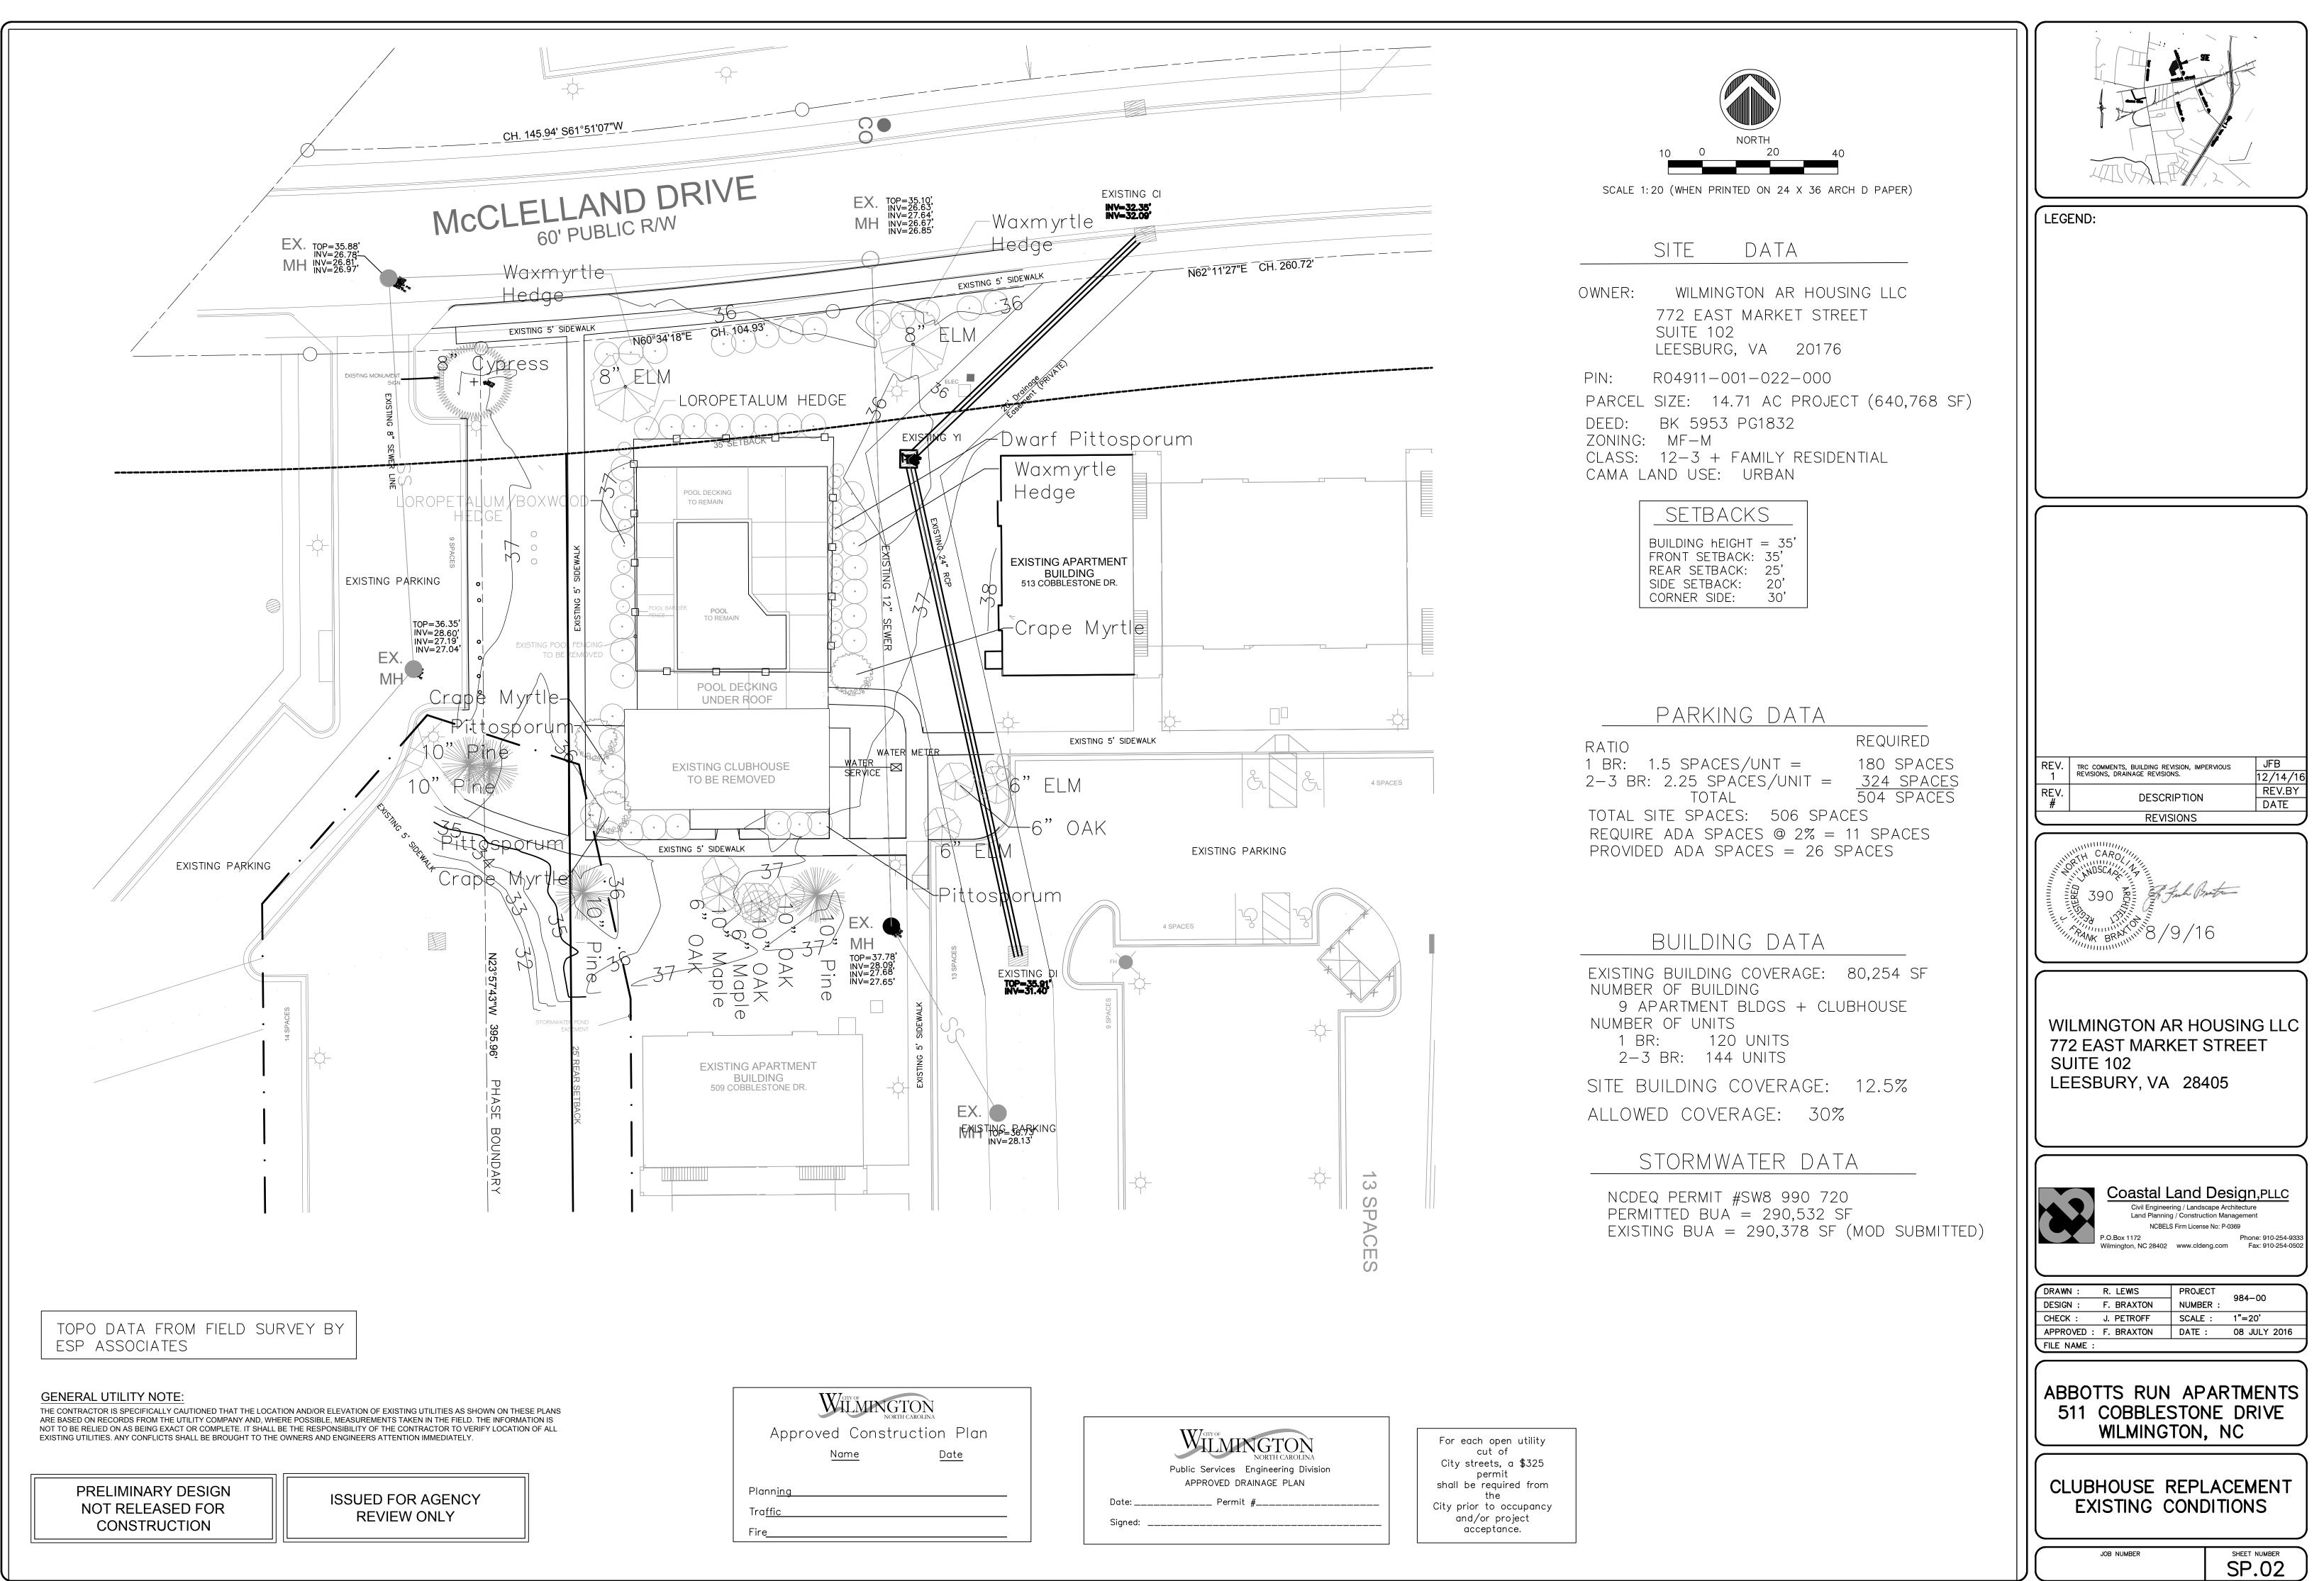

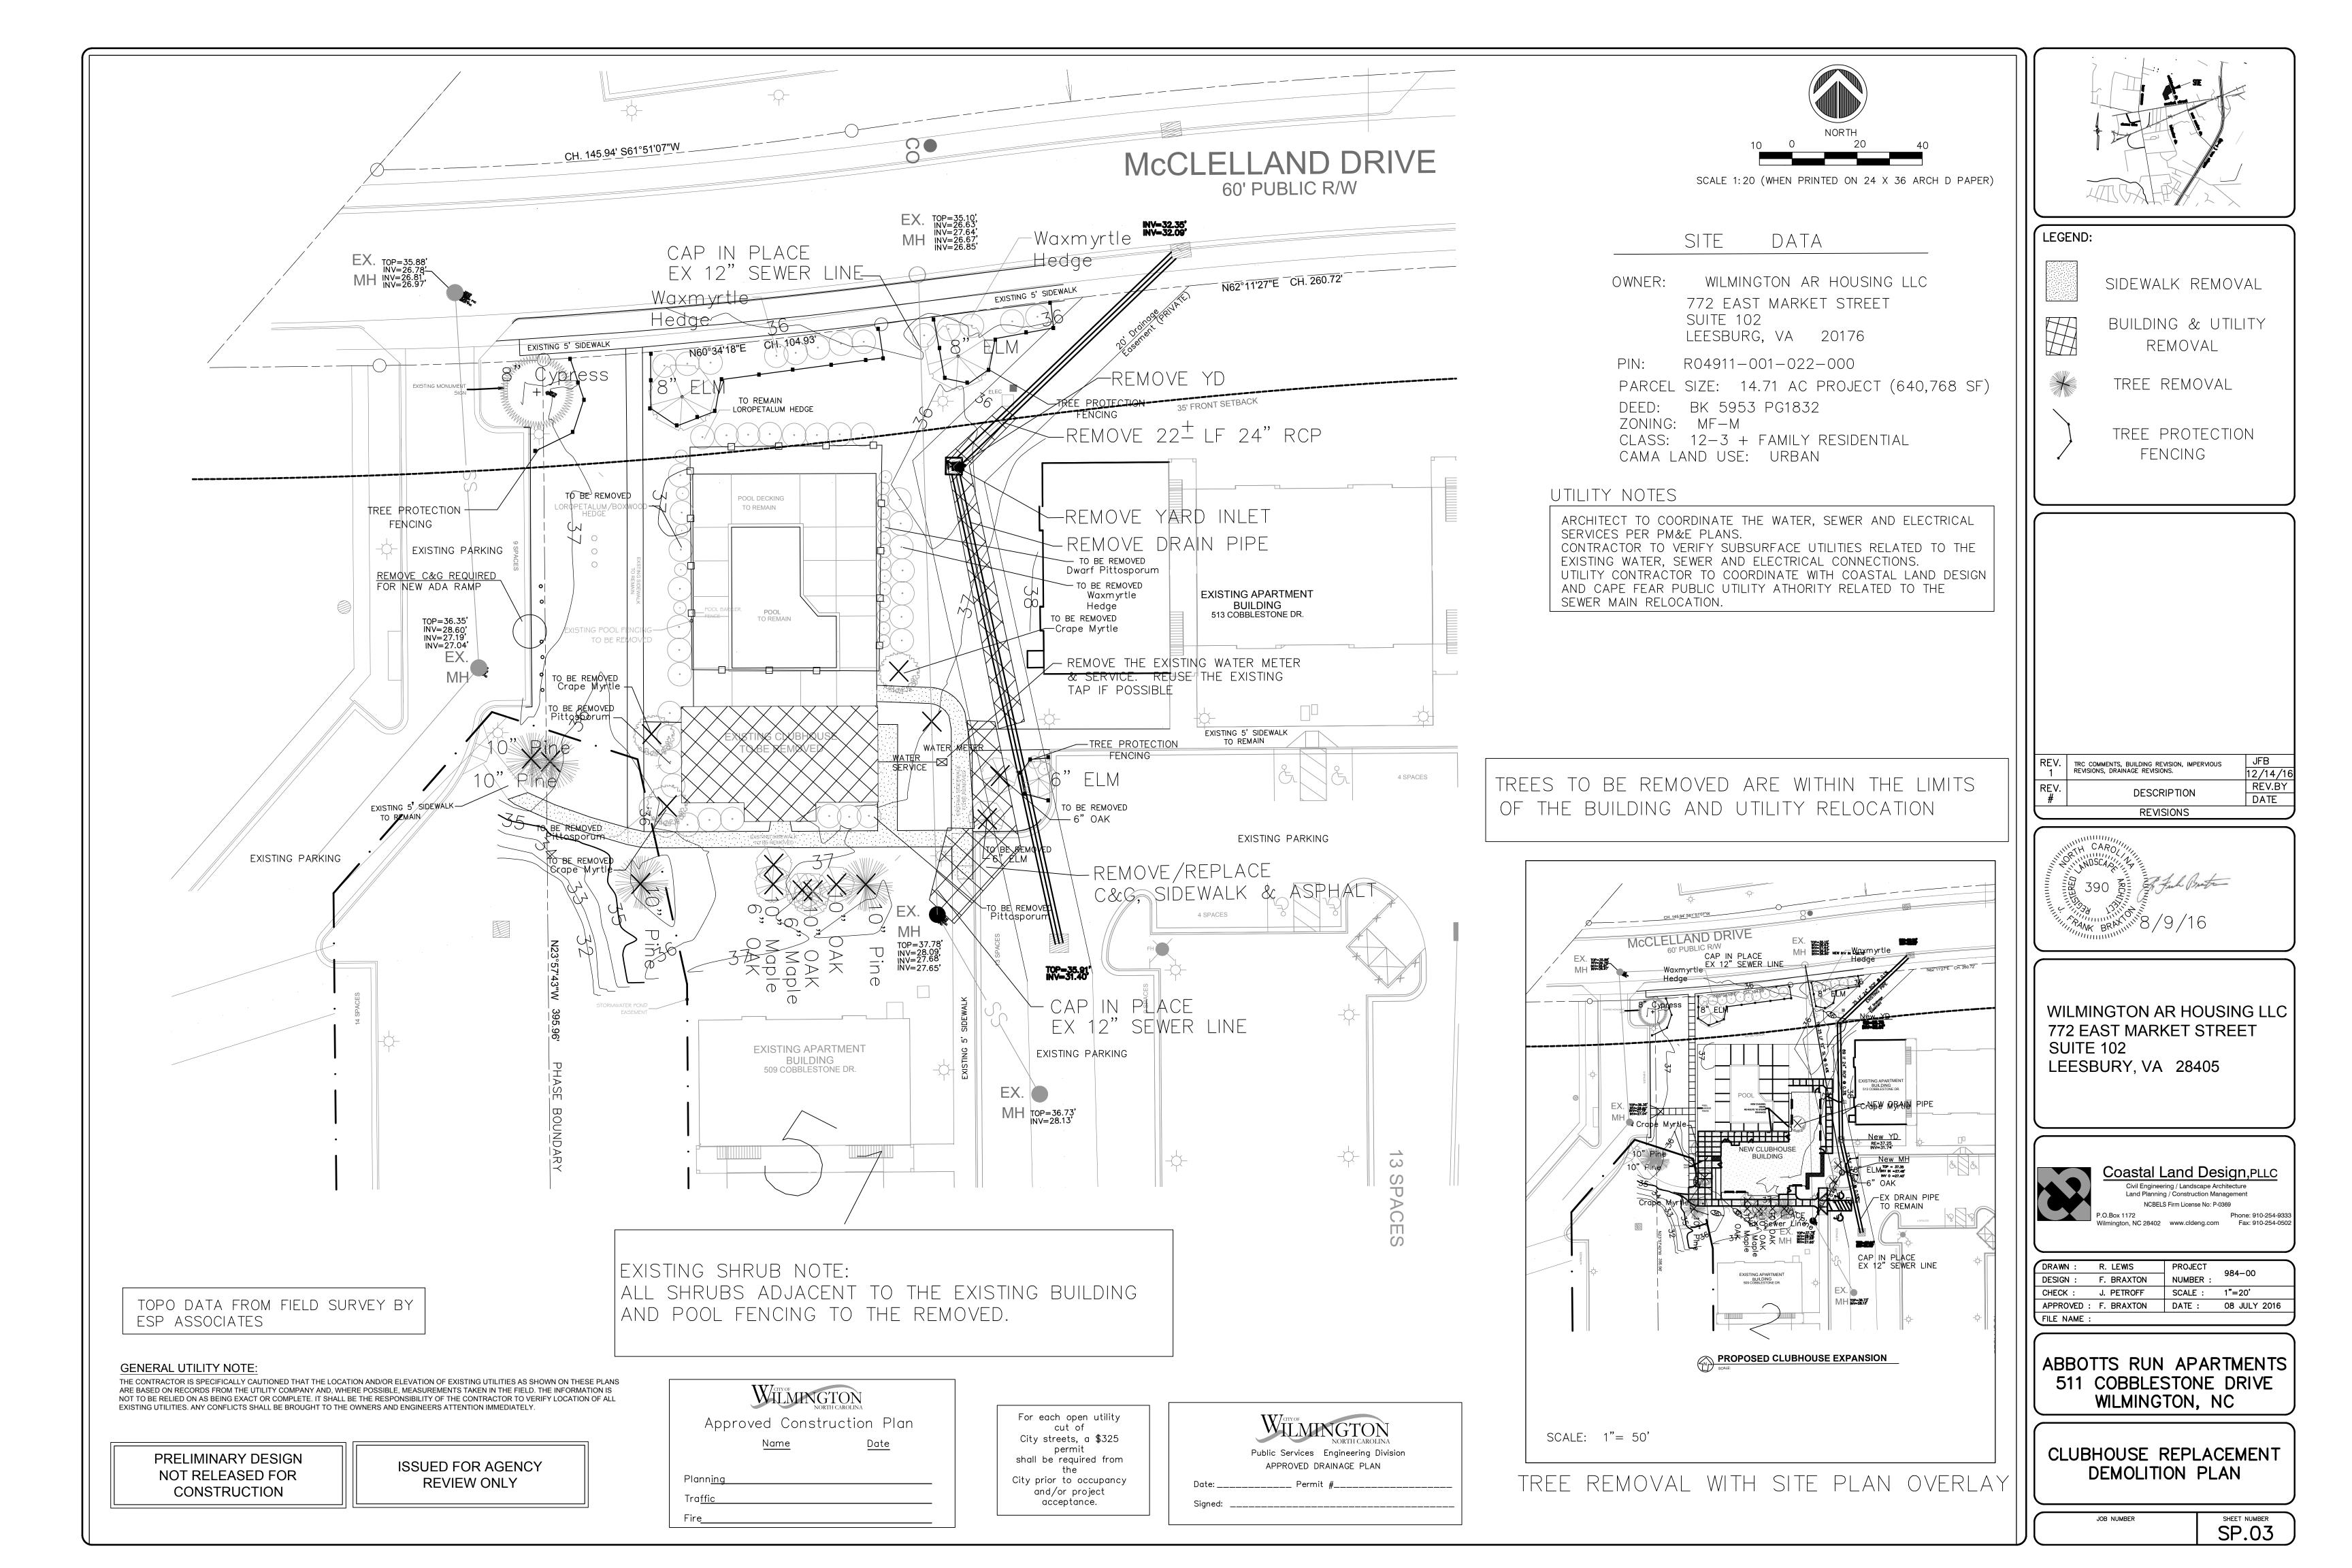

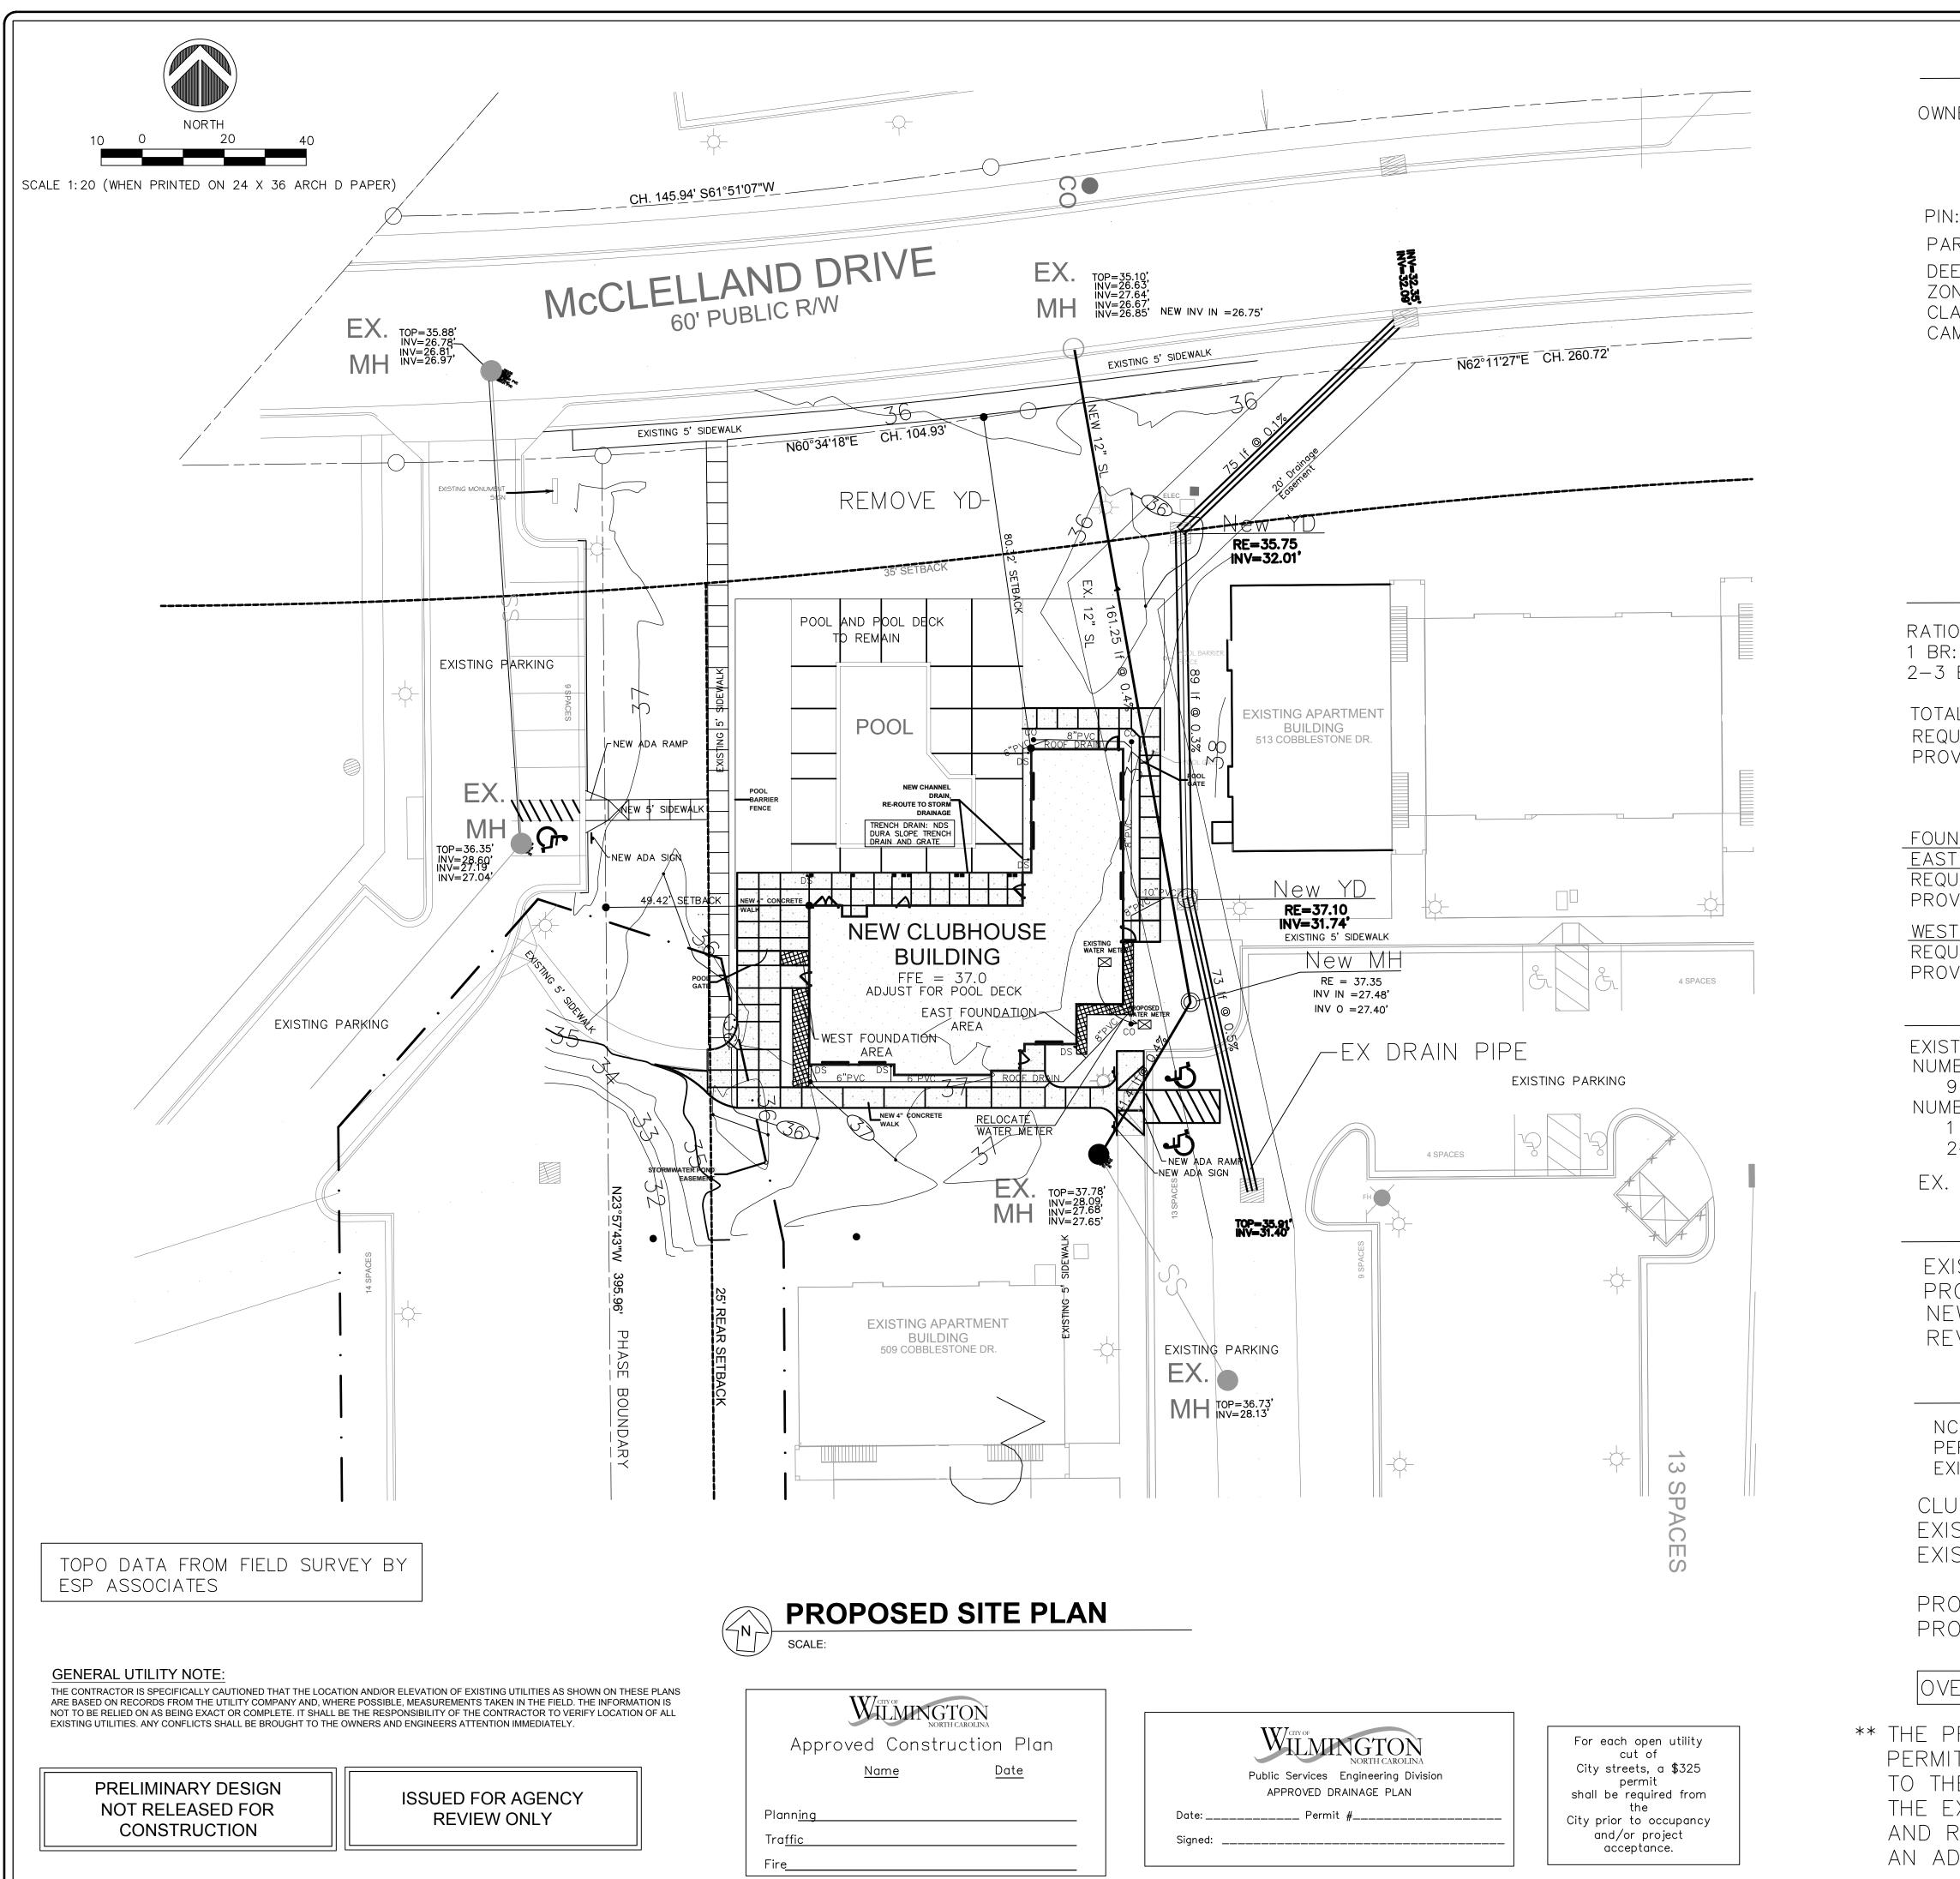SITE DATA NER: WILMINGTON AR HOUSING LLC 772 EAST MARKET STREET SUITE 102 LEESBURG, VA 20176 N: R04911-001-022-000 ARCEL SIZE: 14.71 AC PROJECT (640,768 SF) EED: BK 5953 PG1832 ONING: MF-M LASS: 12-3 + FAMILY RESIDENTIAL AMA LAND USE: URBAN <u>SETBACKS</u> BUILDING hEIGHT = 35' FRONT SETBACK: 25' SIDE SETBACK: 20' CORNER SIDE: 30'	LEGEND:
PARKING DATA REQUIRED R: 1.5 SPACES/UNT = 180 SPACES BR: 2.25 SPACES/ <u>UNIT = 324</u> SPACES TOTAL 504 SPACES AL SITE SPACES: 506 SPACES QUIRE ADA SPACES @ 2% = 10 SPACES DVIDED ADA SPACES = 27 SPACES EXISTING PARKING COUNT OBTAINED BY FIELD VERIFICATION	
UNDATION PLANTINGS (20' BLDG HT) ST QUIRED: 35.8 LF × 20'HT × 0.12 = 86 SF OVIDED: 119 SF ST QUIRED: 38.7 LF × 20'HT × 0.12 = 93 SF OVIDED: 119 SF BUILDING DATA STING BUILDING COVERAGE: 80,254 SF MBER OF BUILDING 9 APARTMENT BLDGS + CLUBHOUSE MBER OF UNITS 1 BR: 120 UNITS	REV.   TRC COMMENTS, BUILDING REVISION, IMPERVIOUS   JFB     1   REVISIONS, DRAINAGE REVISIONS.   12/14/16     REV.   DESCRIPTION   REV.BY     #   DESCRIPTION   REV.BY     B   REVISIONS   DATE     8   390   REVISIONS     9   716
2–3 BR: 144 UNITS SITE BUILDING COVERAGE: 12.5% <u>CLUBHOUSE EXPANSION</u> XISTING FOOTPRINT: 1,598 SF ROPOSE FOOTPRINT: 3,638 SF (2,040 DIF) EW BLDG COVERAGE: 82,294 SF EVISED SITE BUILDING COVERAGE: 13.0% <u>STORMWATER DATA</u>	WILMINGTON AR HOUSING LLC 772 EAST MARKET STREET SUITE 102 LEESBURY, VA 28405
ICDEQ PERMIT #SW8 990 720 PERMITTED BUA = 290,532 SF** UBHOUSE EXPANSION UBHOUSE EXPANSION USTING BLDG AREA: 1,598 SF ISTING SIDEWALKS: 1,342 SF TOTAL 2,940 SF ROPOSED BLDG AREA: 4,121 SF ROPOSED SIDEWALKS: 1,811 SF TOTAL 5,932 SF VERAGE OF BUA: 2,992 SF**	Image: Cost of the second state of
PROPOSED BUA WILL EXCEED THE IIT ALLOWANCE AND COMPLIANCE HE EXISTING NCDEQ STORMWATER PERMIT EXISTING PERMITIS BEING REVISED REISSUED AS A NEW PERMIT WITH ADDITIONAL 15,000 SF OF PERMITTED BUA	CLUBHOUSE REPLACEMENT SITE PLAN JOB NUMBER SHEET NUMBER SP.04




Coastal Land Design, PLLC Civil Engineering / Landscape Architecture Land Planning / Construction Management NCBELS Firm License No: P-0369 Phone: 910-254-9333 /ilmington, NC 28402 www.cldeng.com Fax: 910-254-050 984–00 NUMBER : SCALE : 1"=20' SHEET NUMBER

JFB

12/14/16

REV.BY

DATE

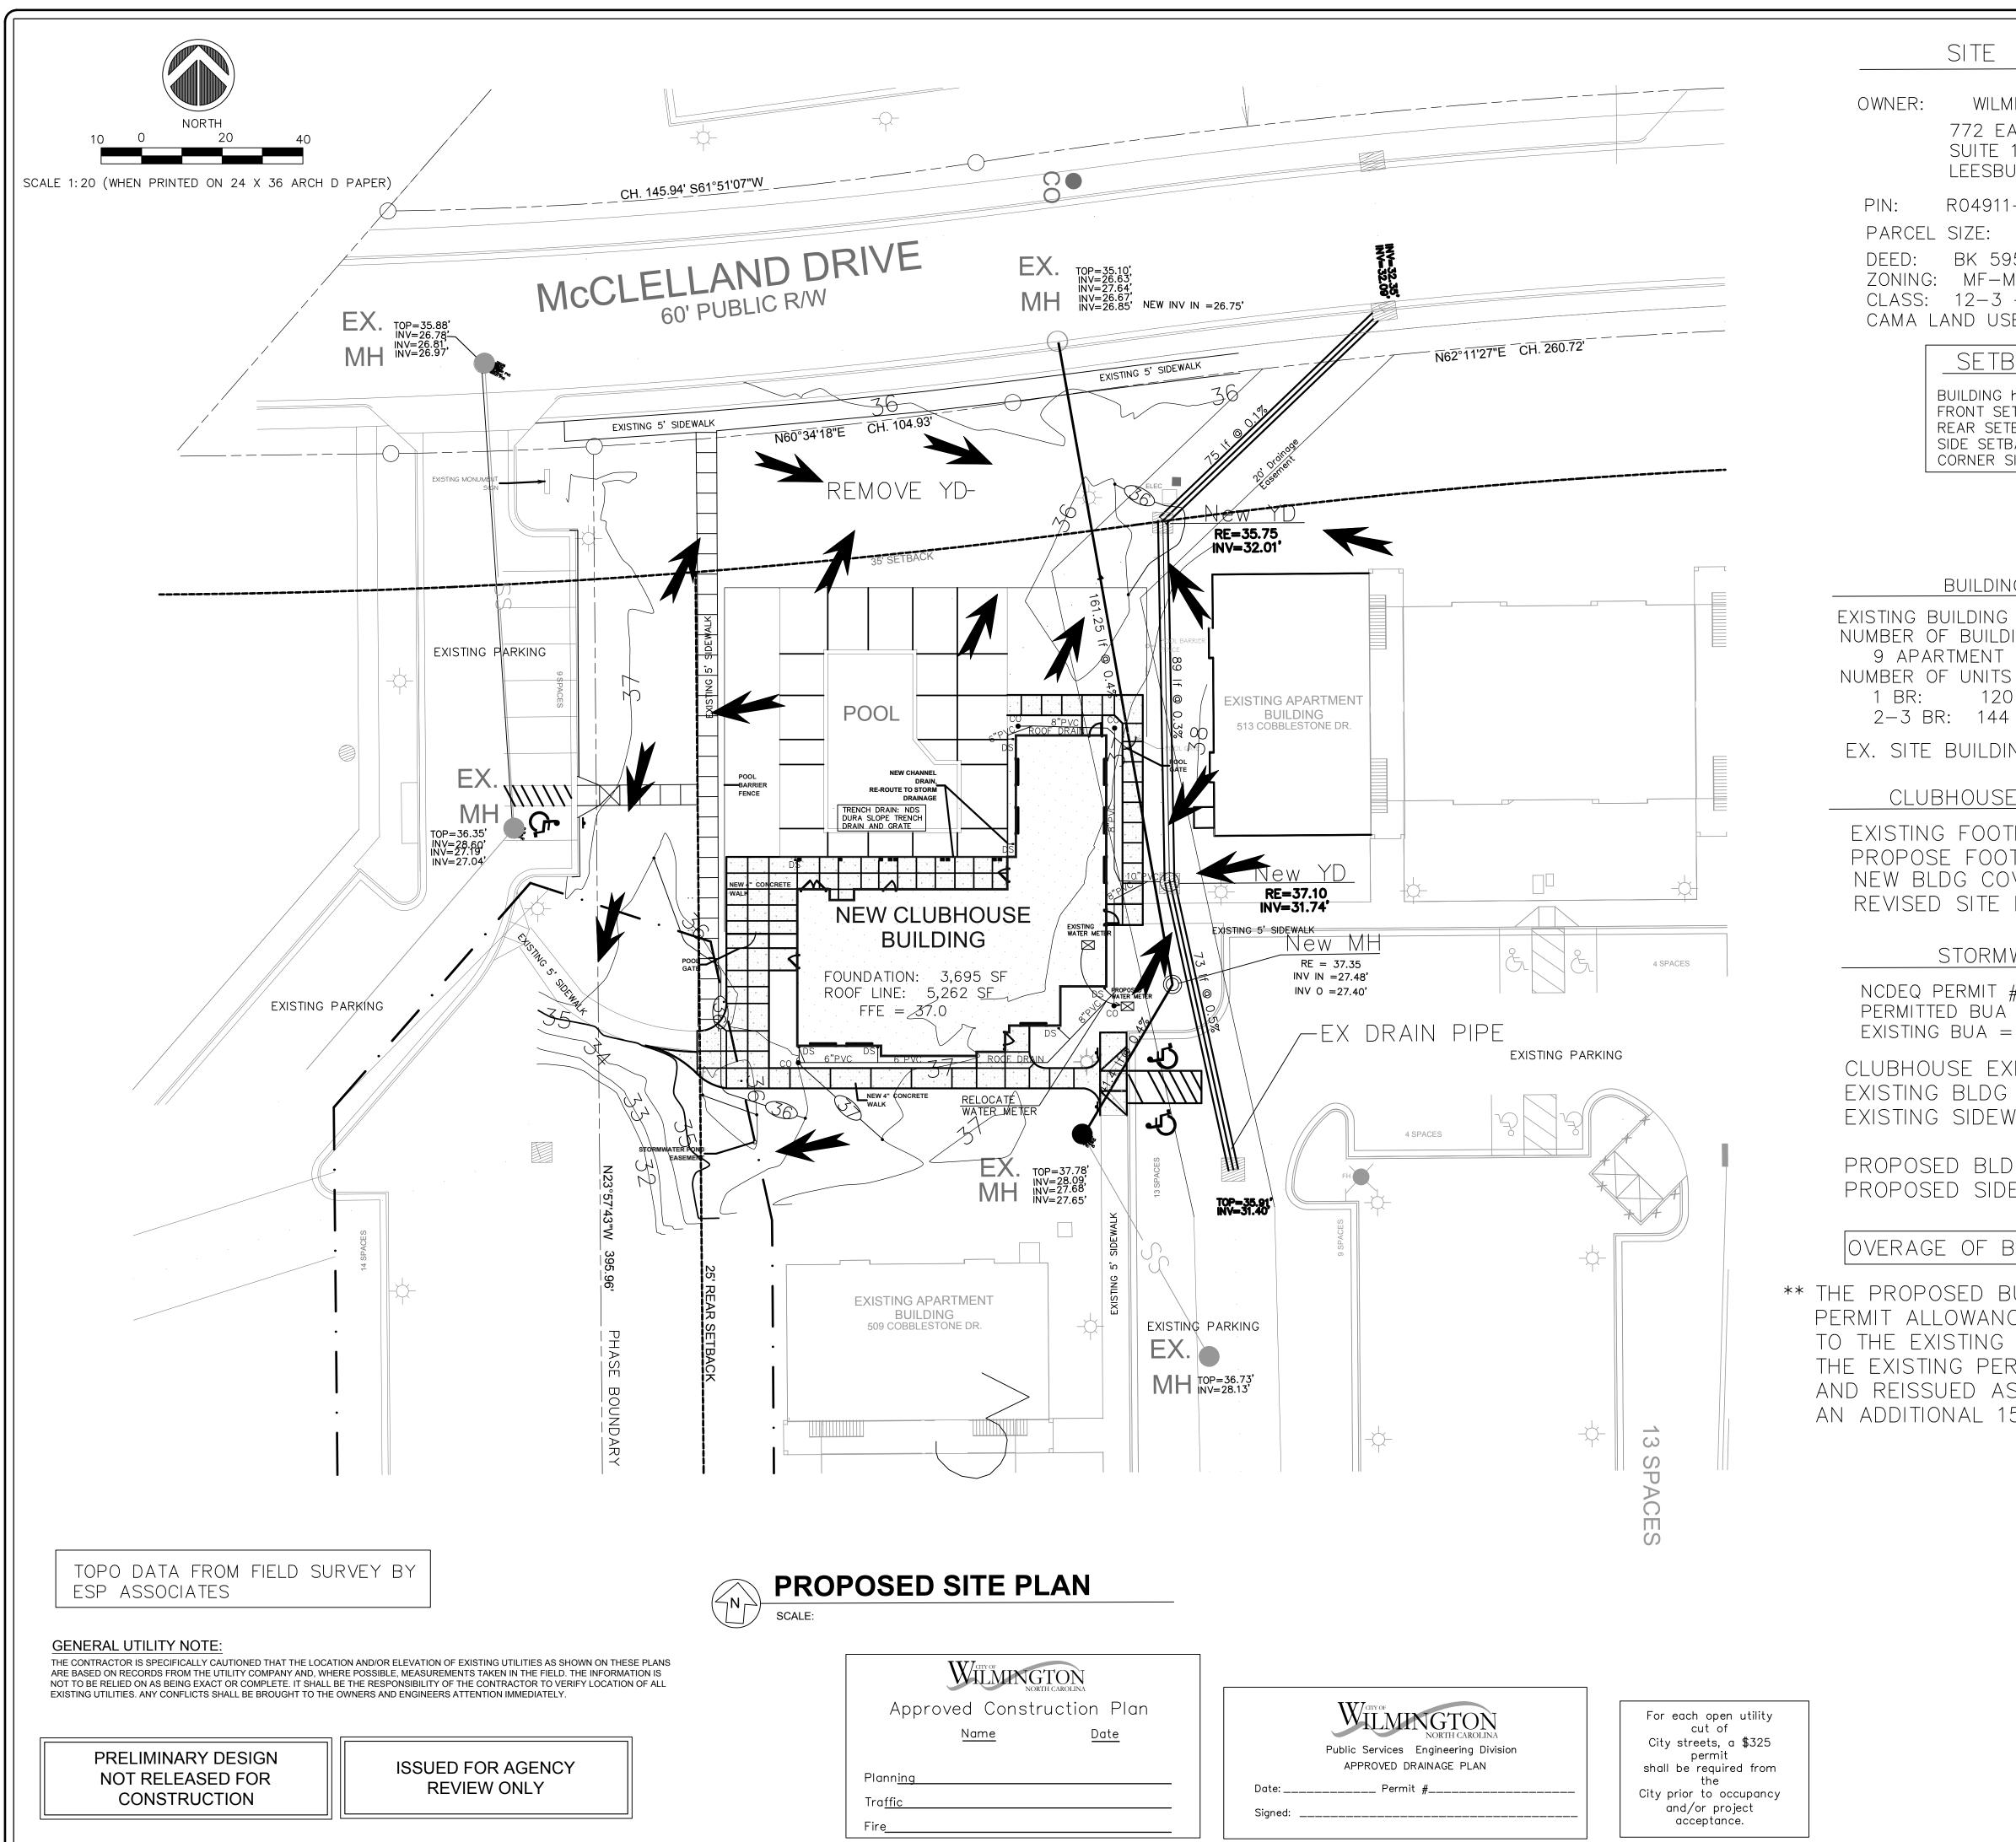

## SITE DATA

OWNER: WILMINGTON AR HOUSING LLC 772 EAST MARKET STREET SUITE 102 LEESBURG, VA 20176 PIN: R04911-001-022-000 PARCEL SIZE: 14.71 AC PROJECT (640,768 SF) DEED: BK 5953 PG1832 ZONING: MF-M CLASS: 12-3 + FAMILY RESIDENTIAL CAMA LAND USE: URBAN

## SETBACKS

BUILDING hEIGHT	= 35'
FRONT SETBACK:	
REAR SETBACK:	25'
SIDE SETBACK:	20'
CORNER SIDE:	30'

EXISTING BUILDING COVERAGE: 80,254 SF NUMBER OF BUILDING 9 APARTMENT BLDGS + CLUBHOUSE NUMBER OF UNITS 1 BR: 120 UNITS 2-3 BR: 144 UNITS EX. SITE BUILDING COVERAGE: 12.5%

#### CLUBHOUSE EXPANSION


EXISTING FOOTPRINT: 1,598 SF PROPOSE FOOTPRINT: 3,638 SF (2,040 DIF) NEW BLDG COVERAGE: 82,294 SF REVISED SITE BUILDING COVERAGE: 13.0%


### STORMWATER DATA

NCDEQ PERMIT #SW8 990 720 PERMITTED BUA = 290,532 SF\*\* EXISTING BUA = 290,532 SF


CLUBHOUSE EXPANSION EXISTING BLDG AREA: 1,598 SF EXISTING SIDEWALKS: 1,342 SF TOTAL 2,940 SF PROPOSED BLDG AREA: 4,121 SF PROPOSED SIDEWALKS: 1,811 SF TOTAL 5,932 SF OVERAGE OF BUA: 2,992 SF\*\*

\*\* THE PROPOSED BUA WILL EXCEED THE PERMIT ALLOWANCE AND COMPLIANCE TO THE EXISTING NCDEQ STORMWATER PERMIT THE EXISTING PERMITIS BEING REVISED AND REISSUED AS A NEW PERMIT WITH AN ADDITIONAL 15,000 SF OF PERMITTED BUA

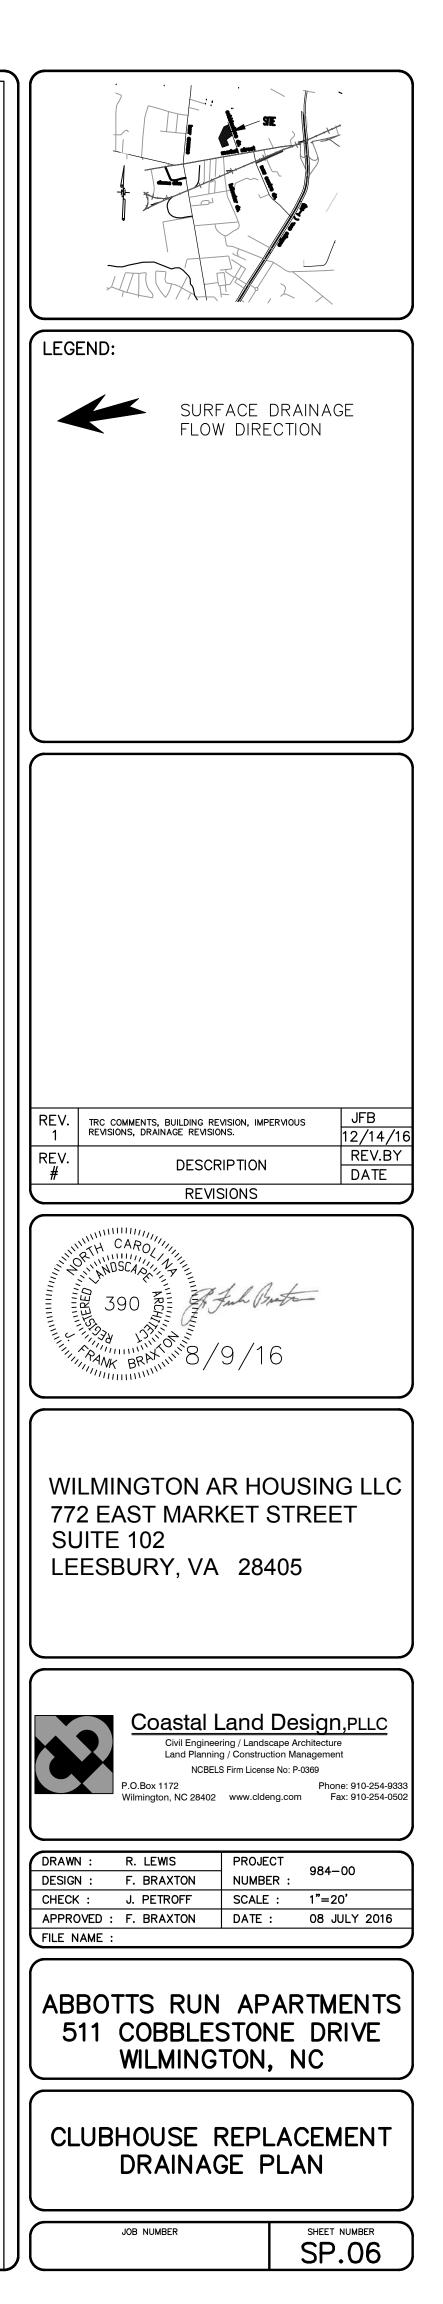

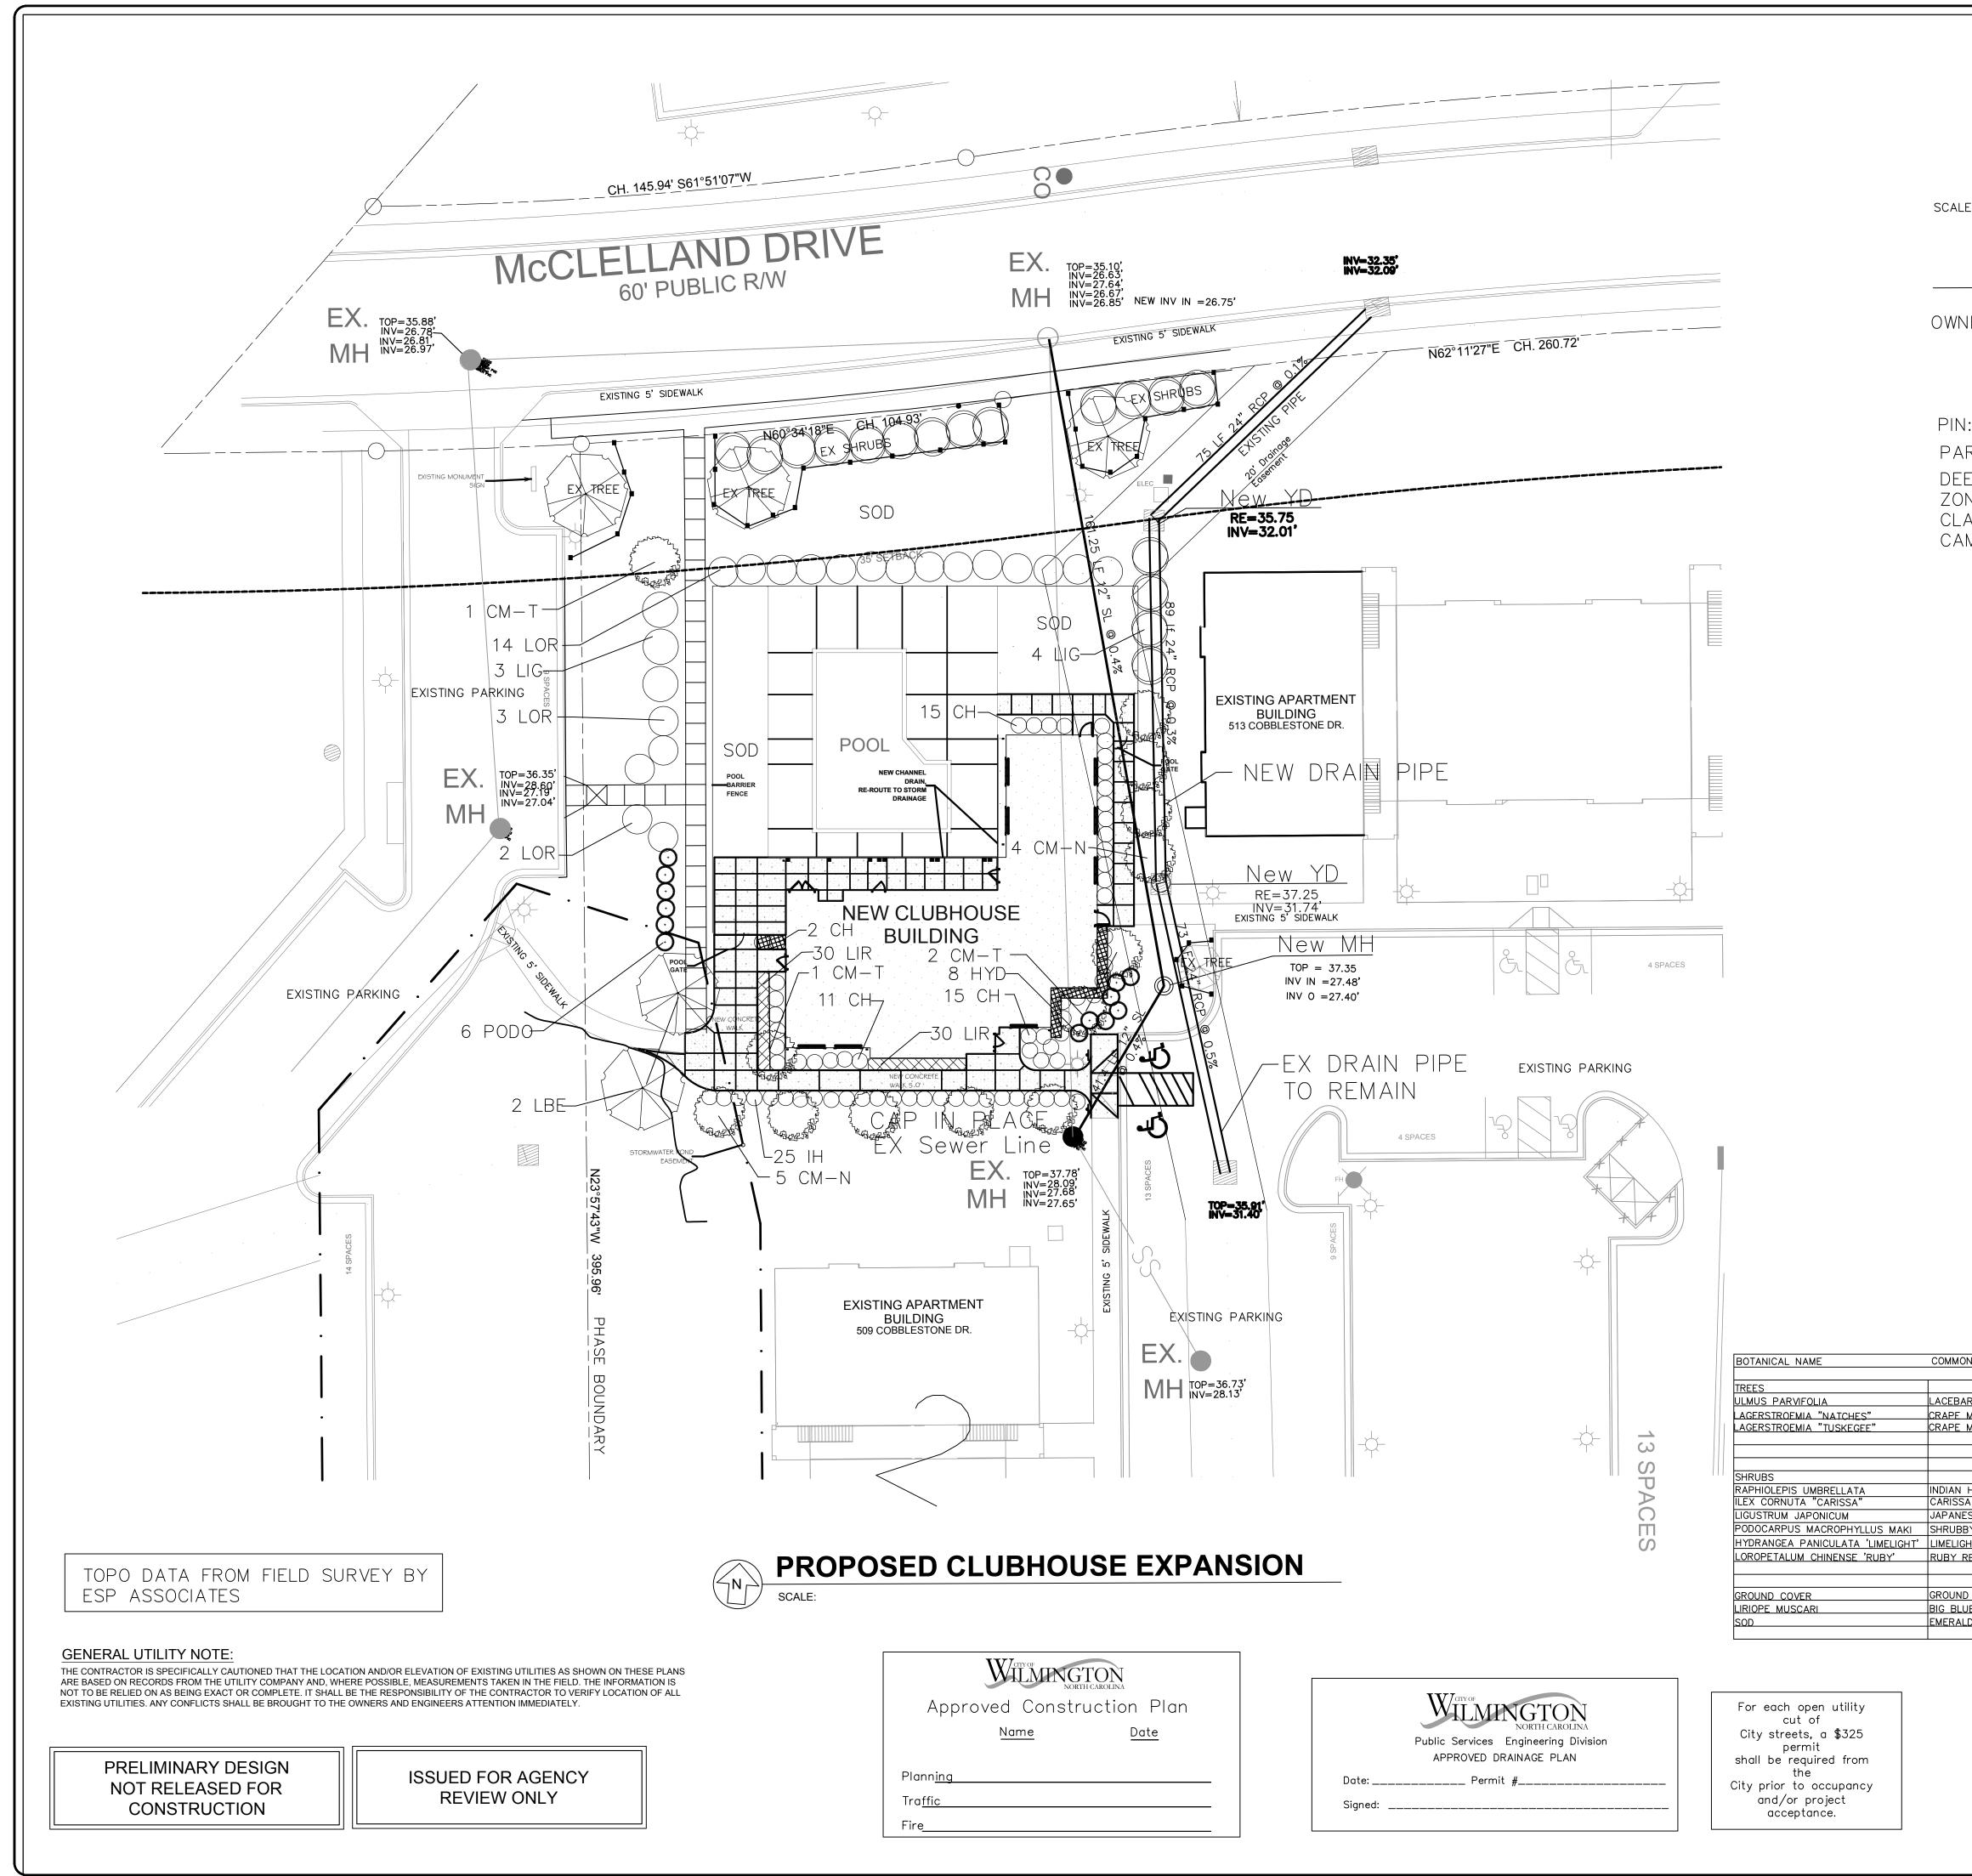

NOR TH 10 0 20 40 LE 1:20 (WHEN PRINTED ON 24 X 36 ARCH D PAPER)	LEGEND:
SITE DATA	LEGEND.
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PLANT LIST	WILMINGTON AR HOUSING LLC 772 EAST MARKET STREET SUITE 102 LEESBURY, VA 28405
ON NAME CALIPER HEIGHT REMARKS QUANTITY SYMBOLS	
MYRTLE "NATCHEZ" 8-10' 9 CM-N   MYRTLE "TUSKEGEE" 8-10' 4 CM-T	Coastal Land Design,PLLC Civil Engineering / Landscape Architecture Land Planning / Construction Management NCBELS Firm License No: P-0369 P.O.Box 1172 Phone: 910-254-9333
HAWTHORN "BLUE MUFFIN" 3 GAL 25 IH SA HOLLY 3 GAL 43 CH	Wilmington, NC 28402 www.cldeng.com Fax: 910-254-9532
ESE LIGUSTRUM6-8'7LIGIBY YEW PODOCARPUS7 GAL6PODOGHT HARDY HYDRANGEA3 GAL8HYDRED LOROPETALUM7 GAL19LOR	DRAWN :R. LEWISPROJECTDESIGN :F. BRAXTONNUMBER :CHECK :J. PETROFFSCALE :1"=20'
ID COVER     ID     <	APPROVED : F. BRAXTON DATE : 08 JULY 2016 FILE NAME :
LD_GREEN_ZOYSIA	ABBOTTS RUN APARTMENTS 511 COBBLESTONE DRIVE WILMINGTON, NC
	CLUBHOUSE REPLACEMENT LANDSCAPE PLAN
	JOB NUMBER SHEET NUMBER SP.07

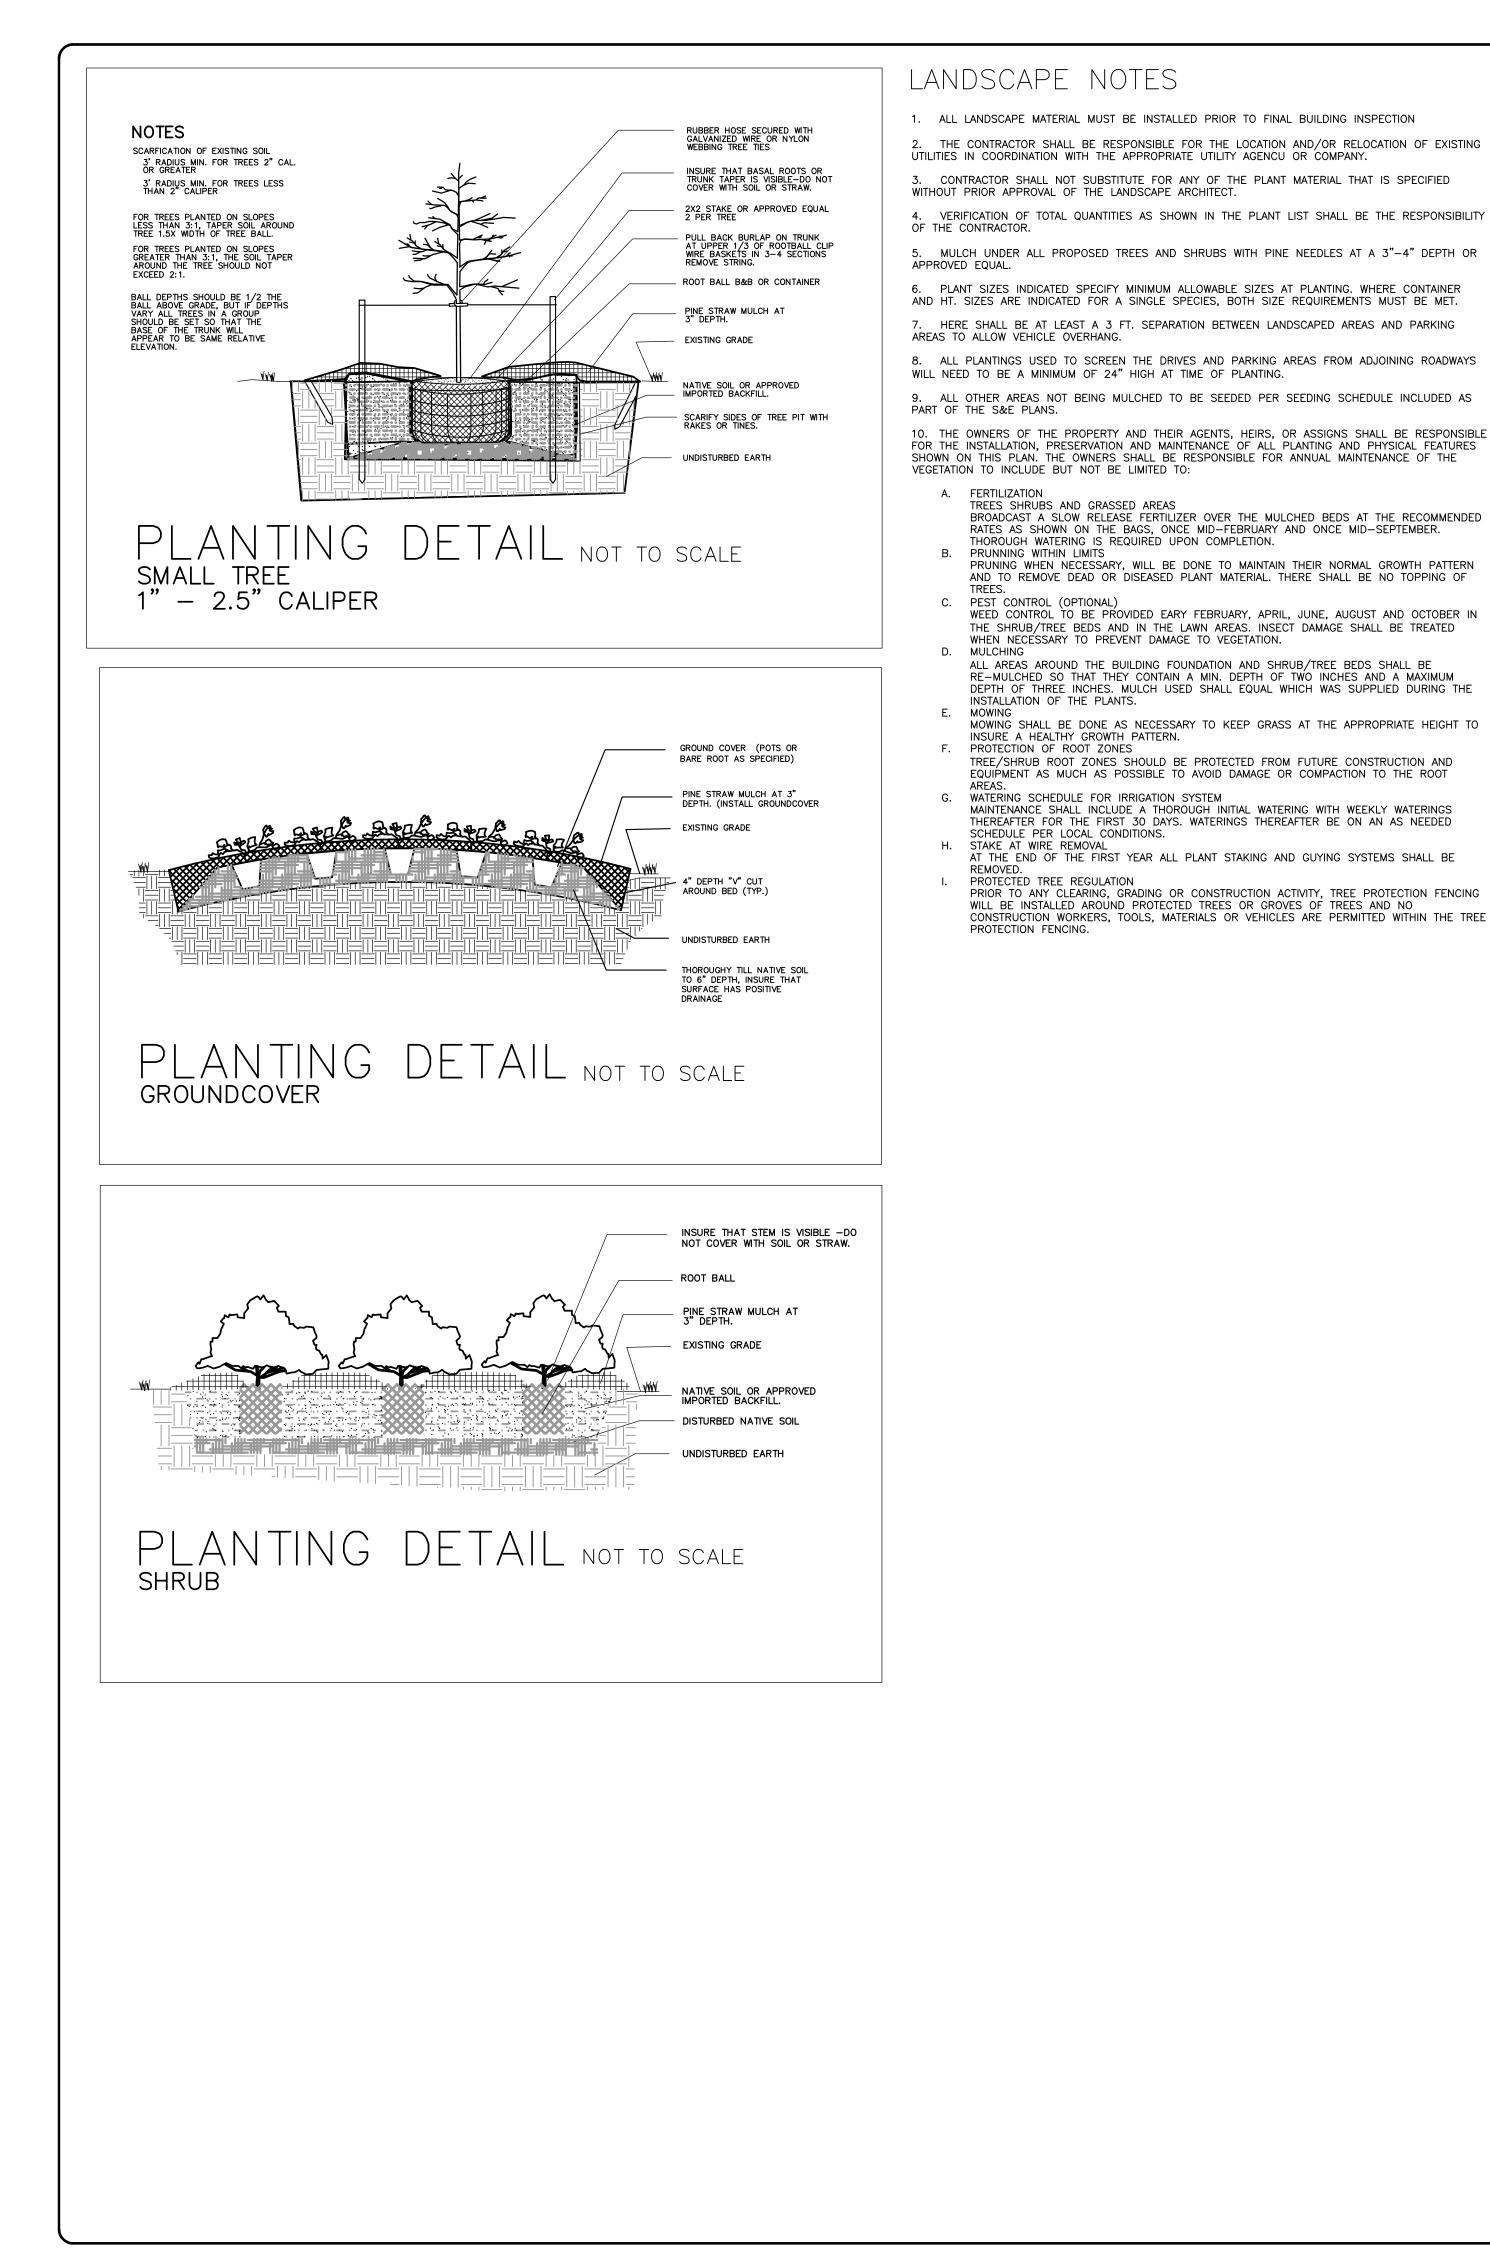

1. ALL LANDSCAPE MATERIAL MUST BE INSTALLED PRIOR TO FINAL BUILDING INSPECTION

2. THE CONTRACTOR SHALL BE RESPONSIBLE FOR THE LOCATION AND/OR RELOCATION OF EXISTING UTILITIES IN COORDINATION WITH THE APPROPRIATE UTILITY AGENCU OR COMPANY.

5. MULCH UNDER ALL PROPOSED TREES AND SHRUBS WITH PINE NEEDLES AT A 3"-4" DEPTH OR

6. PLANT SIZES INDICATED SPECIFY MINIMUM ALLOWABLE SIZES AT PLANTING. WHERE CONTAINER AND HT. SIZES ARE INDICATED FOR A SINGLE SPECIES, BOTH SIZE REQUIREMENTS MUST BE MET. 7. HERE SHALL BE AT LEAST A 3 FT. SEPARATION BETWEEN LANDSCAPED AREAS AND PARKING

8. ALL PLANTINGS USED TO SCREEN THE DRIVES AND PARKING AREAS FROM ADJOINING ROADWAYS

#### 10. THE OWNERS OF THE PROPERTY AND THEIR AGENTS, HEIRS, OR ASSIGNS SHALL BE RESPONSIBLE FOR THE INSTALLATION, PRESERVATION AND MAINTENANCE OF ALL PLANTING AND PHYSICAL FEATURES SHOWN ON THIS PLAN. THE OWNERS SHALL BE RESPONSIBLE FOR ANNUAL MAINTENANCE OF THE

BROADCAST A SLOW RELEASE FERTILIZER OVER THE MULCHED BEDS AT THE RECOMMENDED RATES AS SHOWN ON THE BAGS. ONCE MID-FEBRUARY AND ONCE MID-SEPTEMBER.

PRUNING WHEN NECESSARY, WILL BE DONE TO MAINTAIN THEIR NORMAL GROWTH PATTERN AND TO REMOVE DEAD OR DISEASED PLANT MATERIAL. THERE SHALL BE NO TOPPING OF

WEED CONTROL TO BE PROVIDED EARY FEBRUARY, APRIL, JUNE, AUGUST AND OCTOBER IN THE SHRUB/TREE BEDS AND IN THE LAWN AREAS. INSECT DAMAGE SHALL BE TREATED

ALL AREAS AROUND THE BUILDING FOUNDATION AND SHRUB/TREE BEDS SHALL BE RE-MULCHED SO THAT THEY CONTAIN A MIN. DEPTH OF TWO INCHES AND A MAXIMUM DEPTH OF THREE INCHES. MULCH USED SHALL EQUAL WHICH WAS SUPPLIED DURING THE

MOWING SHALL BE DONE AS NECESSARY TO KEEP GRASS AT THE APPROPRIATE HEIGHT TO

TREE/SHRUB ROOT ZONES SHOULD BE PROTECTED FROM FUTURE CONSTRUCTION AND EQUIPMENT AS MUCH AS POSSIBLE TO AVOID DAMAGE OR COMPACTION TO THE ROOT

MAINTENANCE SHALL INCLUDE A THOROUGH INITIAL WATERING WITH WEEKLY WATERINGS

WILL BE INSTALLED AROUND PROTECTED TREES OR GROVES OF TREES AND NO CONSTRUCTION WORKERS, TOOLS, MATERIALS OR VEHICLES ARE PERMITTED WITHIN THE TREE


## TREE PROTECTION DETAIL NOT TO SCALE

THE CRITICAL ROOT ZONE (CRZ) OF A TREE IS WHERE THE MAJORITY OF A TREE'S ROOTS LAY. 85% OF MOST TREE ROOTS ARE FOUND IN THE TOP 24" OF THE SOIL AND SUPPLY THE MAJORITY OF NUTRIENTS AND WATER. GENERALLY,


> NOTE: CROWN OF THE TREE IS NEEDED FOR LEAF GROWTH TO PRODUCE OXYGEN, FILTER THE AIR, REDUCE WIND AND SOFTEN NOISE. DO NOT DISFIGURE CROWN WITH INTENSIVE PRUNING.

MARK THE TREES AND ERECT A PRÓTECTIVE BARRIER AT THE CRZ. BARRIER

- LOGGING MATTS SHALL BE PLACED WHERE MACHINERY MANEUVERS TO REDUCE SOLOMPACTION IN THIS ZONE.
- REINFORCED SIDEWALK, SHALL BE IMPLEMENTED AS NECESSARY.
- SHALL BE ALLOWED TO PARKUNDER TREES. NO MATERIALS OR EQUIPMENT SHALL BE STORED BENEATH TREES. DAMAGING THE BARK WITH LAWNMOWERS, CONSTRUCTION EQUIPMENT, OR ANYTHING ELSE IS PROHIBITED.
- WORK ORDER AND FINE OF \$500/DAY. DISTURBANCE OTHER THAN THAT ALLOWED ON THE APPROVED PLAN WILL REQUIRE OWNER TO POST A LETTER OF CREDIT FOR 3 YRS FOR TREE MITIGATION.

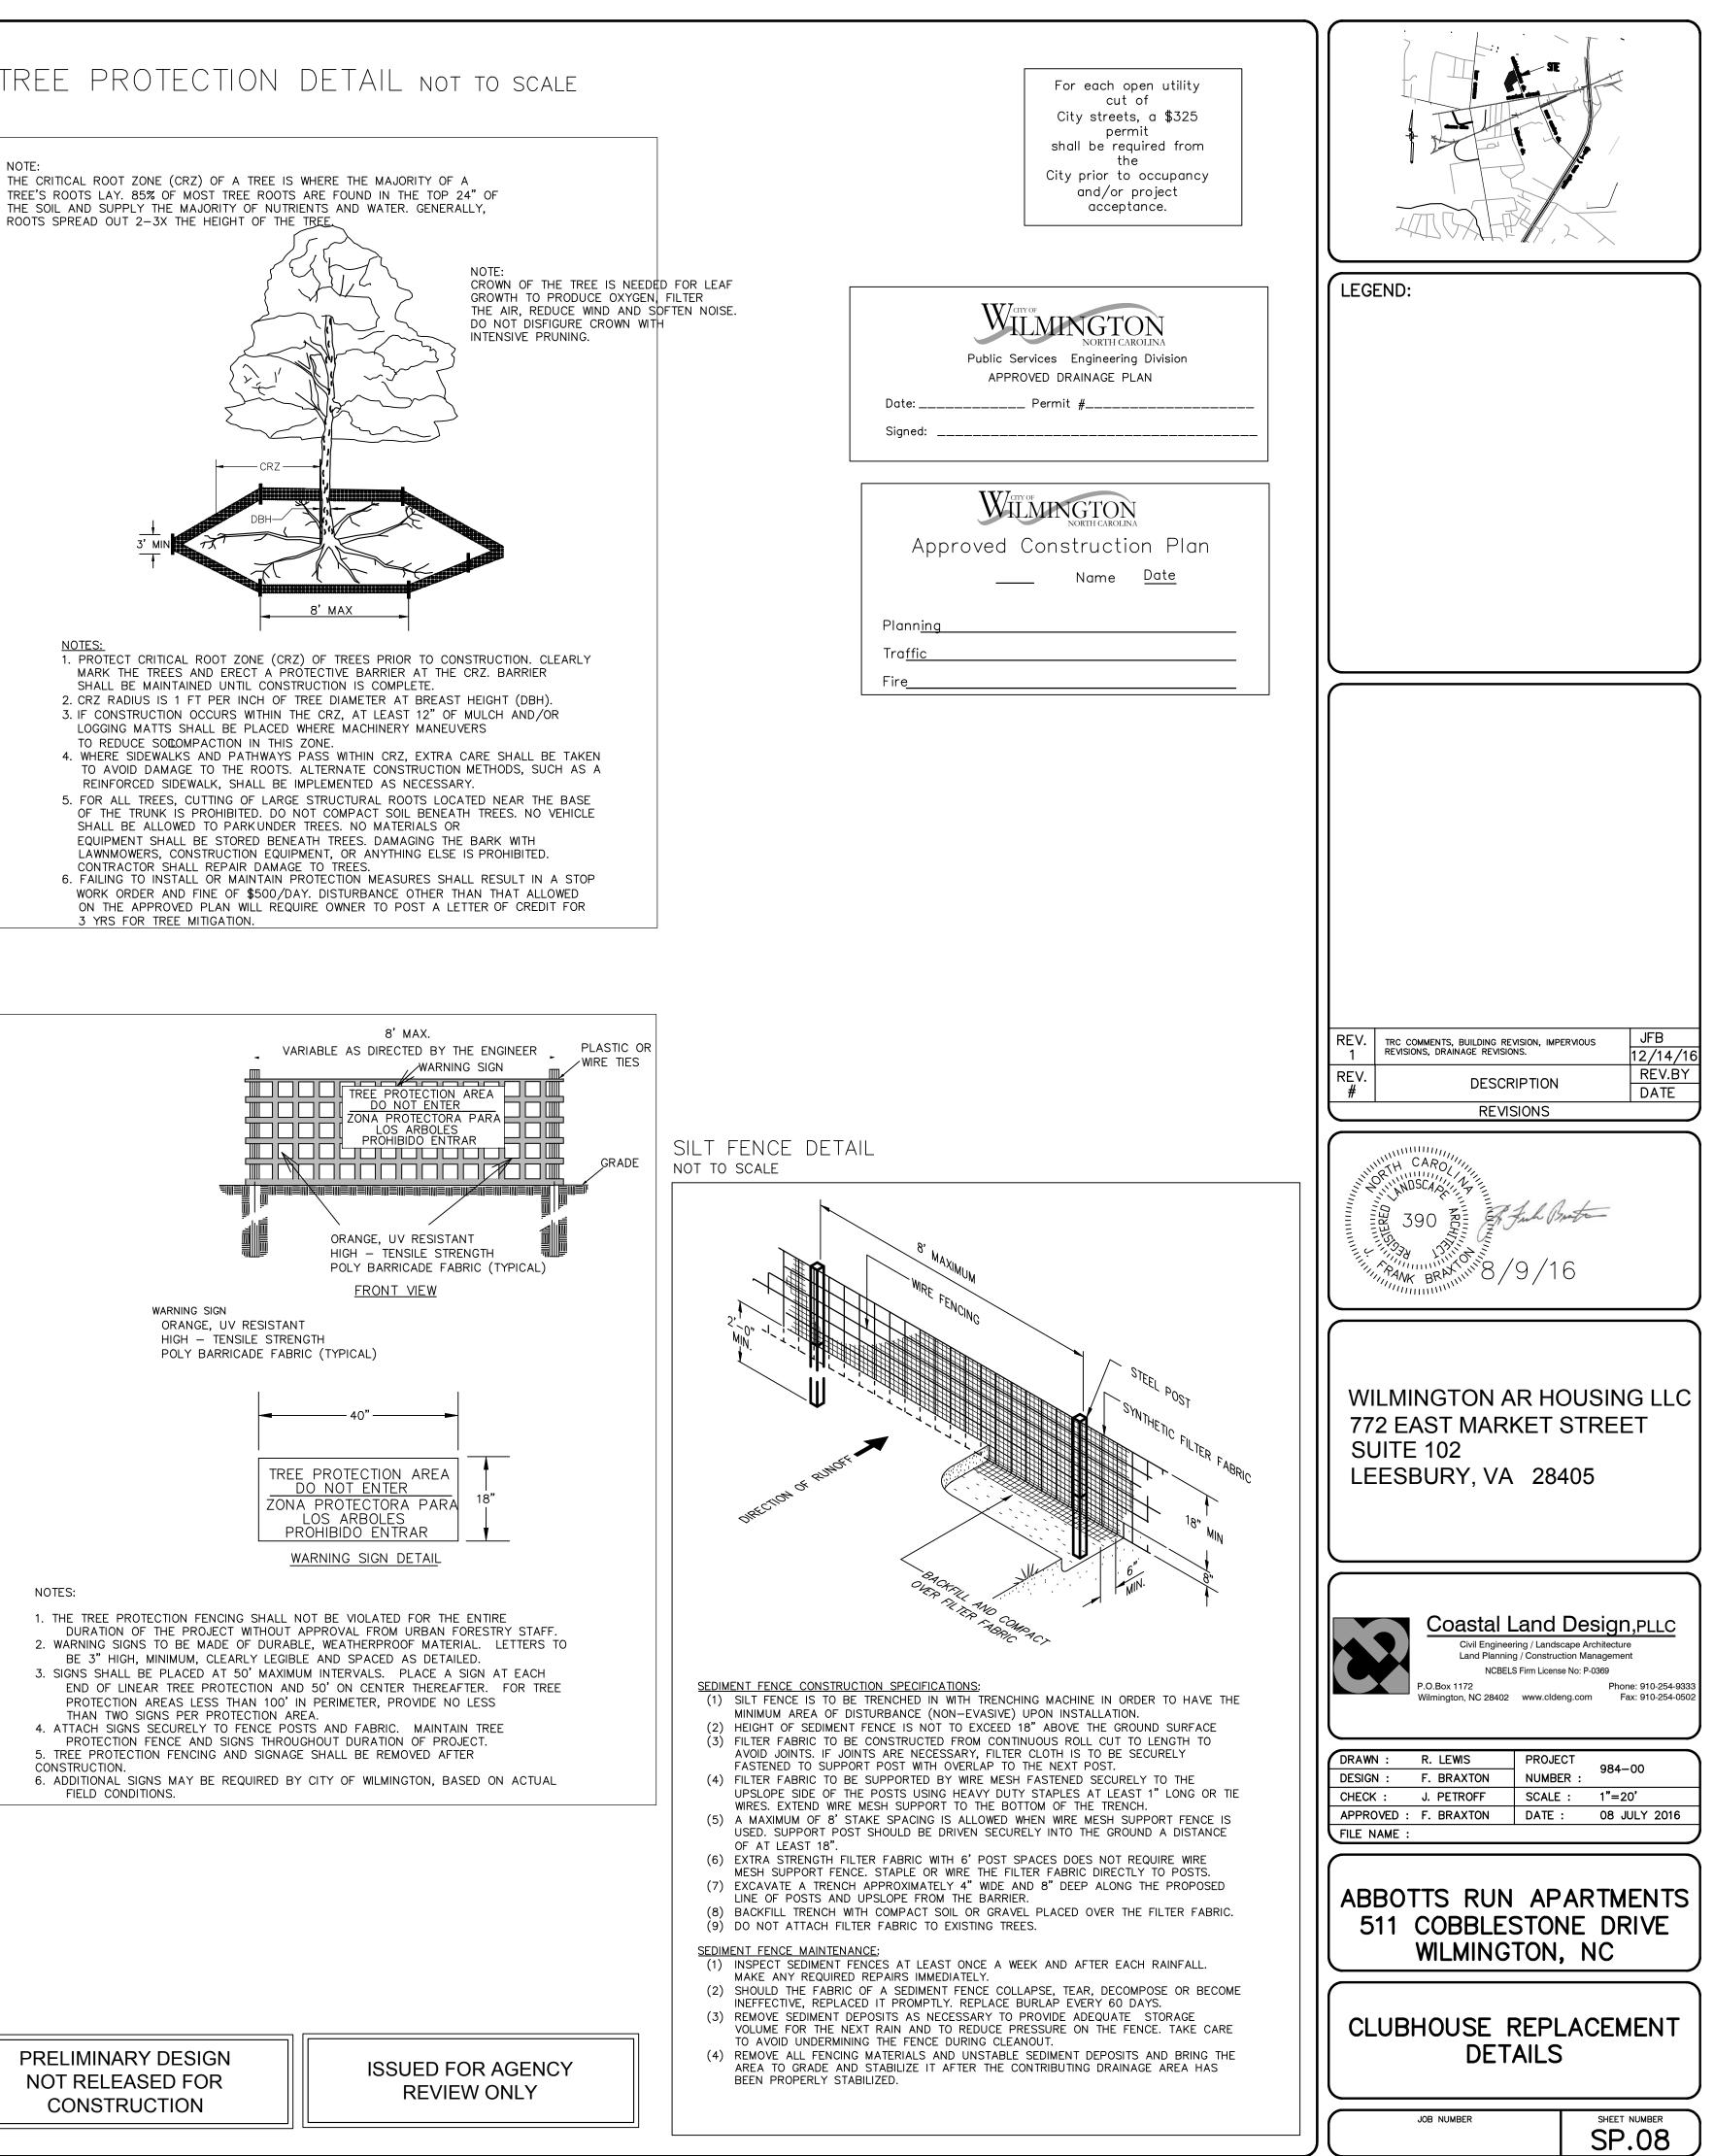

NOT RELEASED FOR

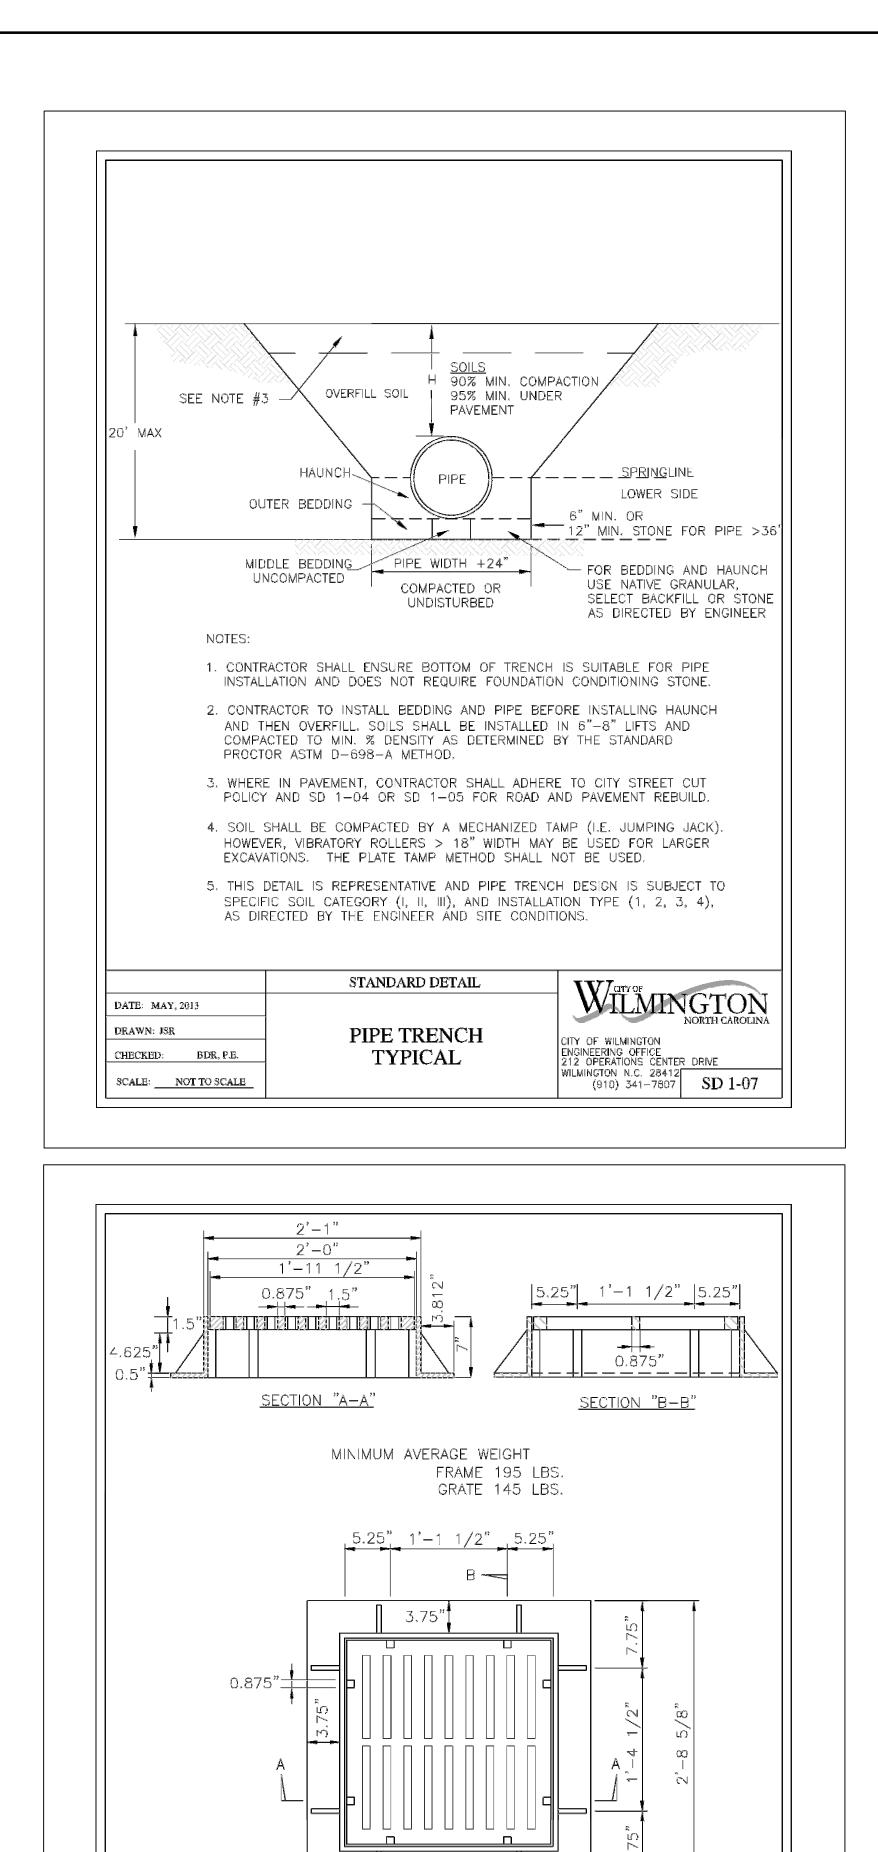

-----0.5"

8.25"

WILMINGTON

CITY OF WILMINGTON ENGINEERING

SD 14-04

PO BOX 1810 WILMINGTON, NC 28402 (910) 341-7807

B \_\_\_\_\_

1'-4 1/8"

2'-8 5/8"

<u>Plan view</u>

STANDARD DETAIL

GRILL BASIN CASTINGS


8.25"


DATE: 2001


DRAWN BY JSR/CMR

CHECKED BY B.P., P.E.

SCALE NOT TO SCALE

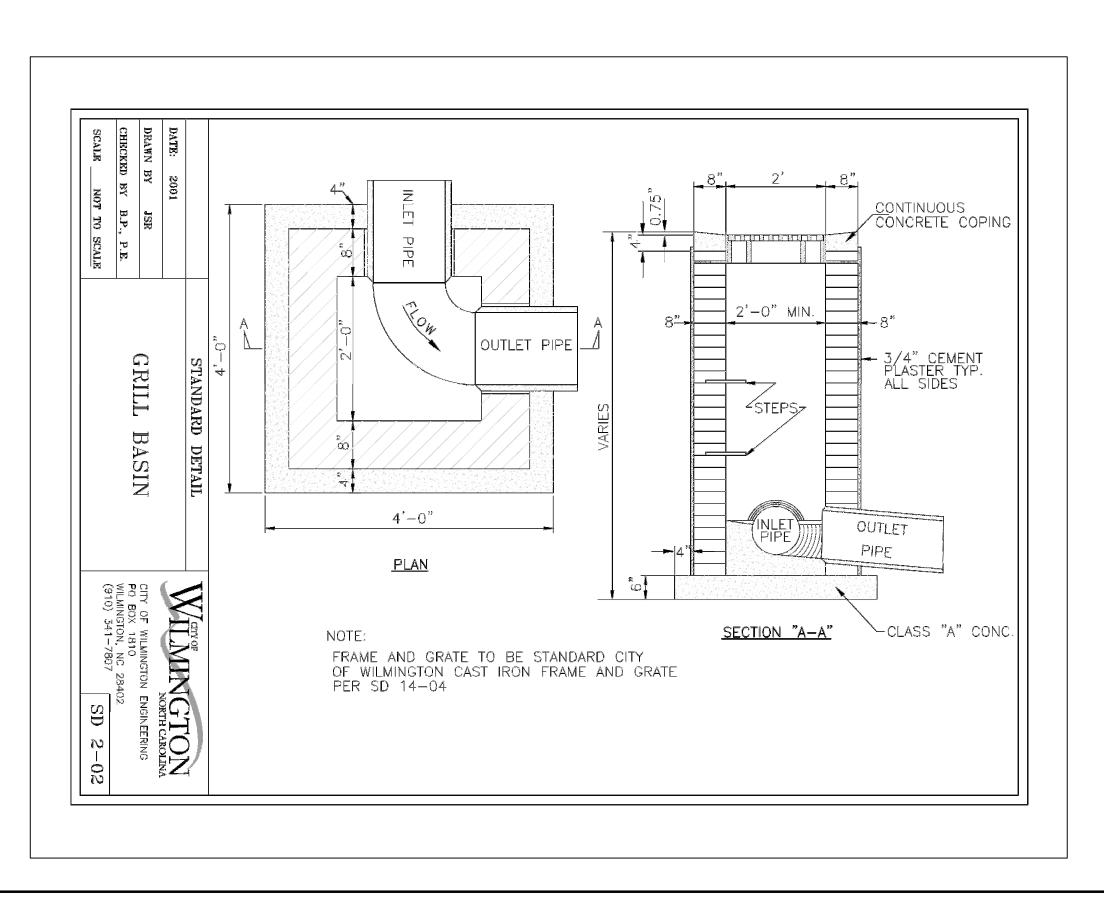

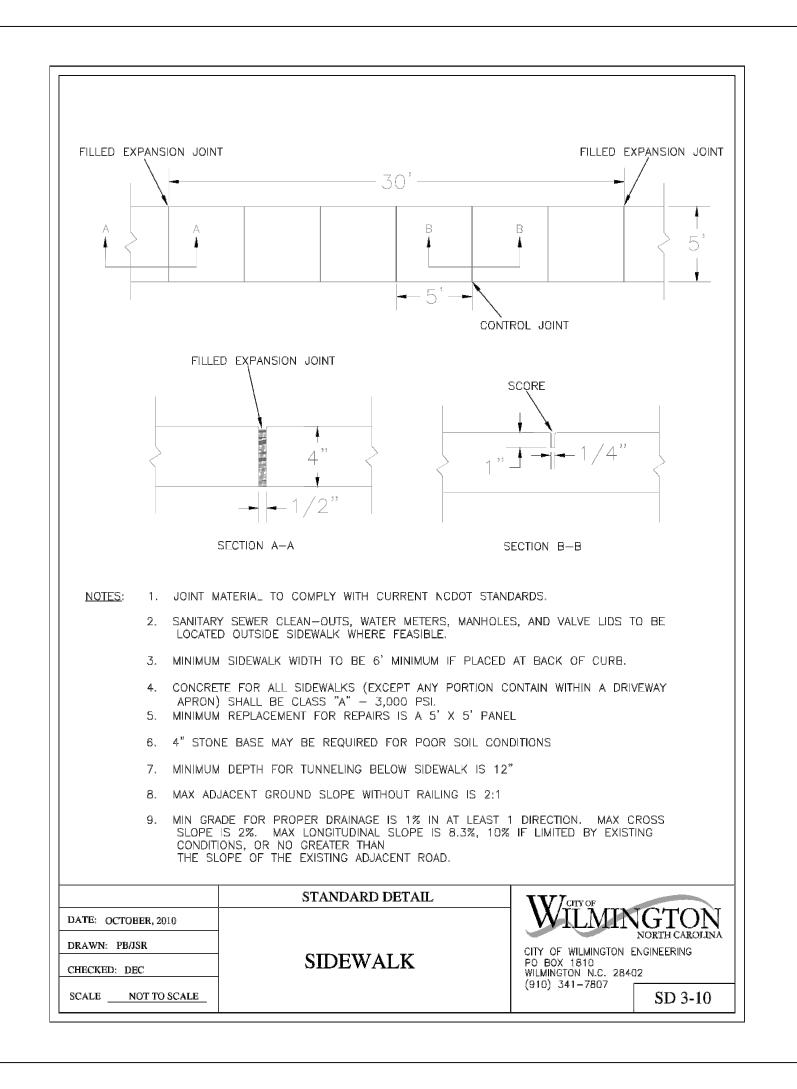

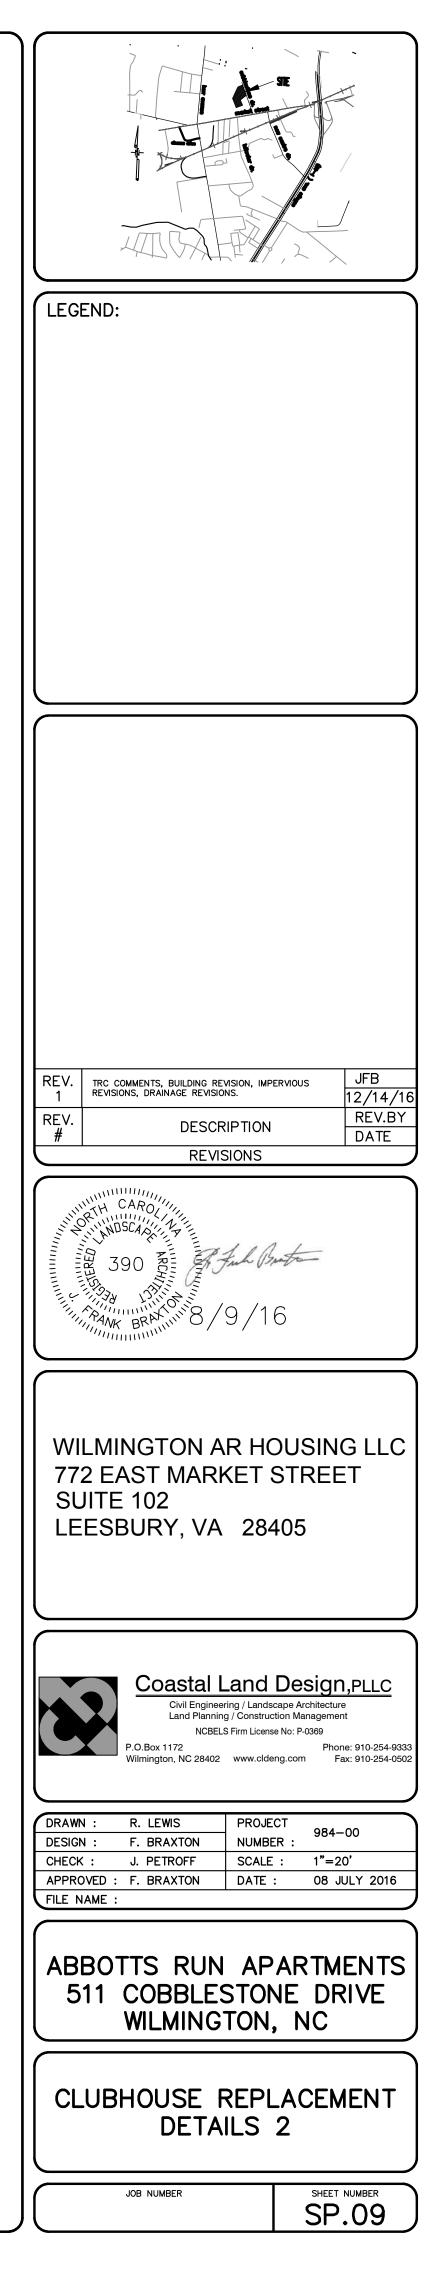

For each open utility cutof City streets, a \$325 permit shall be required from the City prior to occupancy and/or project acceptance.



Public Services Engineering Division APPROVED DRAINAGE PLAN

\_\_\_ Permit #


Date: \_ Signed:

## WILMINGTON


Approved Construction Plan Name <u>Date</u>

Planning

Tra<u>ffic</u> Fire\_

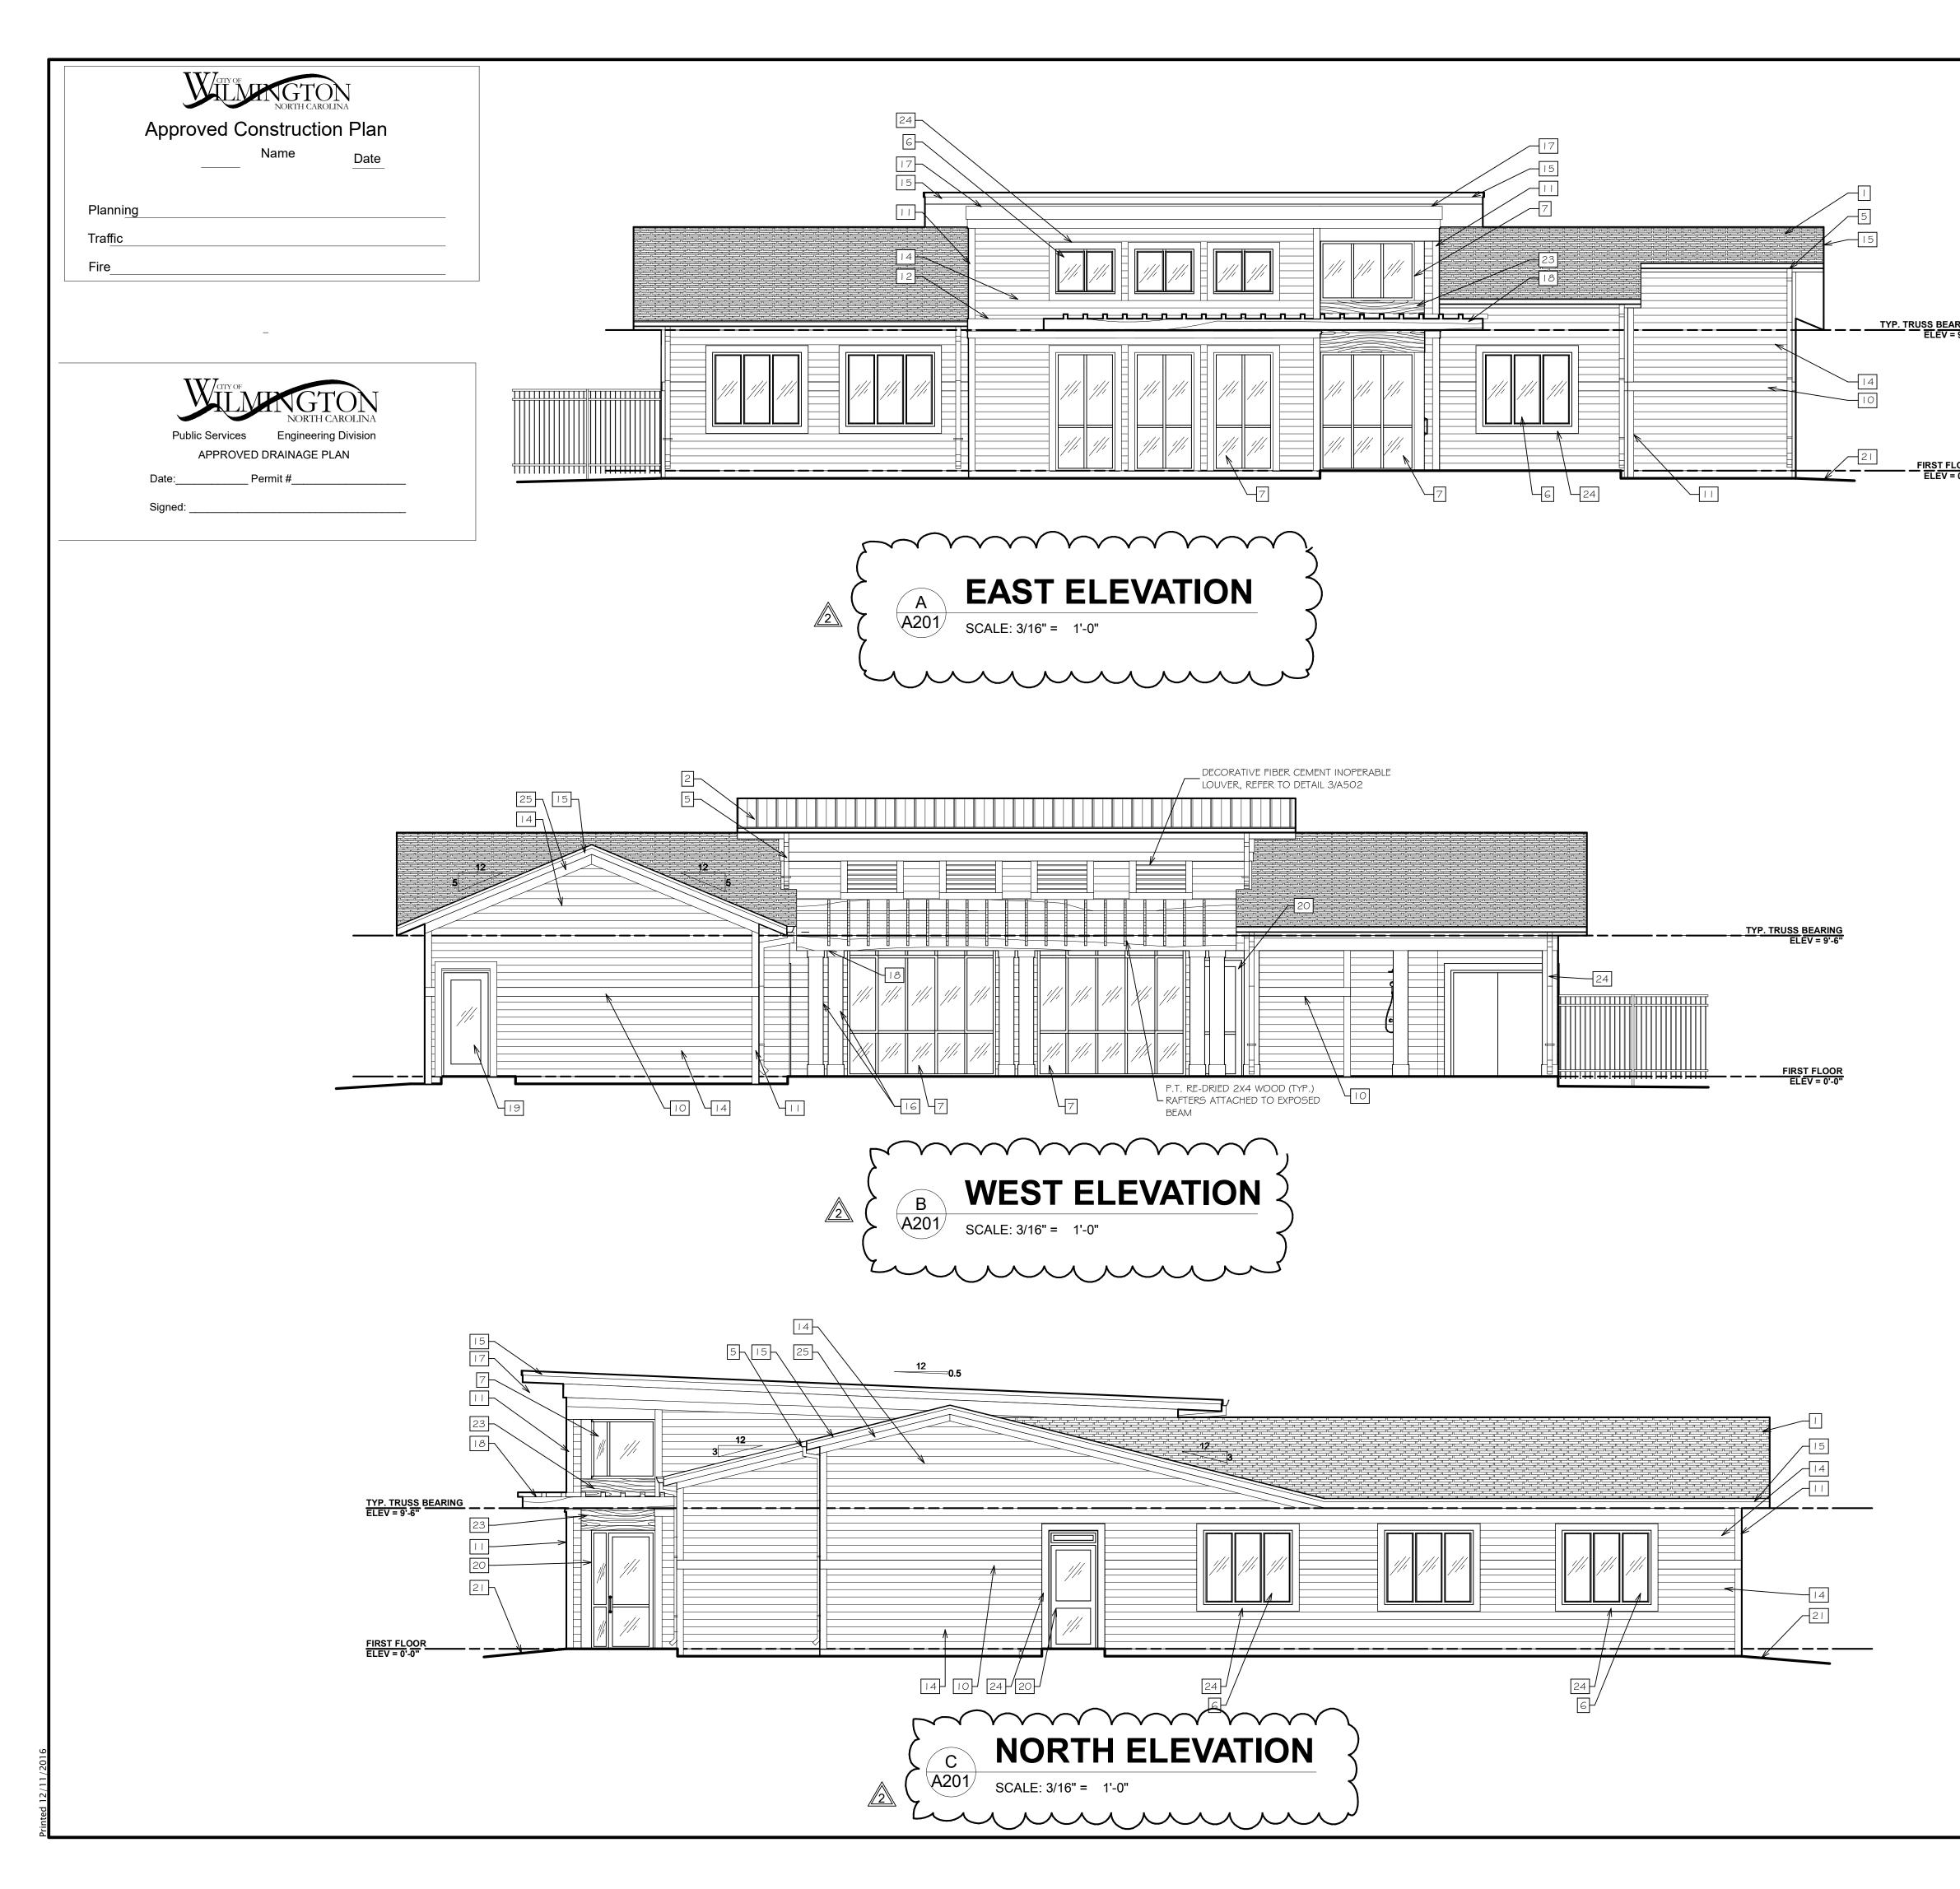

	ELEVATION KEYNOTES				
	2.				
	3.				
	4.	ELECTRICAL METER CENTER (SEE ELEC. DWG'S)			KOT HOSTETLER
	5.		TER AND DOWNSPOUT		
	6.		WINDOW (JELD-WEN OR EQUAL)	<u>-</u>	
	7.		NT SYSTEM (OR ALTERNATE), REFER TO	ARCI	HITECTURE ■PLANNING
	8.	ELEVATIONS SHEE			
	9.	NOT USED		29	006 MARKET STREET, SUITE 101 WILMINGTON, NC 28403
	10.	5/4 X 8 FIBER CEN	MENT WALL BAND	P	HONE: Shawn - 910.612.1119
RING 9'-6"	11.	5/4 X G FIBER CEN	MENT TRIM		Greg - 910.612.4364 www.kot-hostetler.com
	12.	5/4 X I O" FIBER C	EMENT SKIRT BOARD		www.kol-nosteller.com
	13.		MENT SKIRT BOARD		
	14.		P SIDING WITH 6" EXPOSURE	CONSU	LTANTS
	5.  6.		FASCIA AND MTL. DRIP EDGE C COLUMN SURROUND WITH 9 1/4" PVC BASE		
			ERE SHOWN), (CHADSWORTH - 'SQUARE NON-		
. <u>OOR</u> 0'-0"		TAPERED' OR EQU	AL)		
0-0	17.	NOT USED			
	18.	SUNSHADE STRUC	CTURE: P.T. AND RE-DRIED 4X10 BEAM AND WALL		
			HORIZ. LOUVERS (STAIN AND SEAL)		
	19.				
	20. 21.	APPROX. FINISHED	FRAME (REFER TO OPENING SCHED. SHT AGOI)		
	22.		RIER FENCE, REFER TO DETAIL 1/A002		
	23.		P SIDING WITH 4" EXPOSURE PAINTED ACCENT		
		COLOR		1	
	24.	5/4 X G FIBER CEN	MENT WINDOW/DOOR SURROUND TRIM	<b> </b>	
	25.		MENT RAKE BOARD		W CLUBHOUSE FOR
	26. EVT	5/16" FIBER CEME			
			ERIALS LEGEND		
	FIBER	CEMENT SOFFIT: MANUF:	JAMES HARDIE BUILDING PRODUCTS, INC.		
		PRODUCT STYLES:	A. VENTED SMOOTH (HARDIESOFFIT) B. NON-VENTED SMOOTH (HARDISOFFIT) C. BEADED PORCH PANEL (HARDIESOFFIT)		
		PROFILE: FINISH:	.25" FACTORY PRIMED, FINISH W/ 100% ACRYLIC EXTERIOR		<b>BOTTS RUN</b>
		COLOR:	PAINT (2 COATS MIN.) T.B.D.		PARTMENTS
		FASTENERS:	PER MANUF. RECOMMENDATIONS		
	FIBER	CEMENT SIDING: MANUF.:	JAMES HARDIE BUILDING PRODUCTS, INC.		
		PRODUCT:	A. HARDIE TRIM BOARDS (SIZE INDICATED ON DRAWINGS) B. 5/16" THICK LAP SIDING W/ 6" EXPOSURE (HARDIPLANK) C. 5/16" PANEL (HARDIPANEL VERTICAL SIDING)		
		FINISH:	FACTORY PRIMED, FINISH W/ 100% ACRYLIC EXTERIOR PAINT (2 COATS)	l wil	MINGTON AR HOUSING,
			PER MANUE RECOMMENDATIONS	N I	LLC
	COLTO	RED STONE TILE: MANUF.: PRODUCT:	COVERALL STONE, INC. STACKED PEBBLE TILE		
	4	FINISH: FASTENERS:	STACKED PEBBLE TILE STACKED SEASIDE OCEAN BLEND (PT-ST-OB) PER MANUF. RECOMMENDATIONS		
2	Ļ	ACCESSORIES: GROUT:	N/A GRAY	4	
		SUBSTRATE:	MORTER BED ON WIRE MESH AND SCRATCH COAT, ON 1/2" CEMENT BOARD (VERIFY WITH MANUF.)	4	NORTH CAROLINA
	ROOF A	ASSEMBLY DESCRIPTION		TS	
	FIBERG	GLASS SHINGLES -		LER ARCHITECTS GISTRATION	TIFR ARCAIN
		ROOFING:	GRANULAR SURFACED, FIBERGLASS REINF. ASPHALT SHINGLE	RAT	ST SE NACHTECTURE
		MANUF.: PRODUCT:	GAF MATERIALS CORPORATION TIMBERLINE HD	ER AI GISTI	52570 E
		COLOR: TRIM: FLASHINGS:	TO BE SELECTED FROM MANUF. FULL LINE .032 KYNAR COATED ALUMINUM (COLOR T.B.D.) .032 KYNAR COATED ALUMINUM (COLOR T.B.D.)		
		ACCESSORIES: PRO ESS	VIDE STANDARD ACCESSORIES AND ITEMS ENTIAL TO COMPLETION OF ROOF INSTALLATION INCLUDING	HOSTETLE TATE REG	MILMINGTON.
		HIP	AND RIDGE SHINGLES, RIDGE VENT, CLOSURES, FLASHING, 'T' LE DRIP EDGE AND FASCIA	KOT HOSTI STATE	Contraction of the second seco
			OR COORDINATED PRIMERLESS SILICONE OR HIGH	N N N	
			DE, NON-DRYING BUTYL AS REQUIRED BY MANUF.		
		SHIE AT S	ELD AT HIPS AND VALLEYS ON (1) LAYER OF 30# ROOFING FELT ELOPES GREATER THAN 4:12, OR (2) LAYERS OF 15# ROOFING	<b>RECORD</b> TETLER	WIN E. HOSTA
		FELI	TAT SLOPES LESS THAN 4:12.	T OF RECO HOSTETLE	STATE ALL ALL ALL ALL ALL ALL ALL ALL ALL AL
	$\sim$		CCESSORIES AND PENETRATION DETAILS AS REQUIRED BY	<b>Т ОF</b> НОS1 926	11926
	EXPOS	ED FASTENER METAL PA	ANEL -		6.24.16
	(	PANEL LENGTH: METAL:	ONE PIECE SINGLE LENGTH PANEL .040 ALUM. (COLOR T.B.D.)	ARCHITEO SHAWN E.	MINGTON, NG
(		DEPTH: TRIM:	1 1/2" .040 ALUM. (COLOR T.B.D.)	SH. AR	Construction of the second sec
^	$\succ$	SEAMS: PANEL WIDTH:	EXPOSED FASTENER INTERLOCKING 36" MATCH CHACE AND EINISH OF BOOF DANELS		
2	>	FLASHINGS: ACCESSORIES:	MATCH GUAGE AND FINISH OF ROOF PANELS		<b>RUCTION DOCUMENTS :</b> 11.30.16
		AUDEUUUNIEU.	ESSENTIAL TO COMPLETION OF A STANDING SEAM ROOF INSTALLATION INCLUDING ANCHOR CLIPS, TRIM,	$\langle$	REVISIONS
	(		RIDGE, CLOSURES, FLASHING AND FASCIA		DATE DESCRIPTION
	>	SEALANT:	COLOR COORDINATED PRIMERLESS SILICONE OR HIGH GRADE, NON-DRYING BUTYL AS REQUIRED BY MANUF.		11.30.16 VE REVISIONS
	$\succ$	SUBSTRATE:	5/8" EXT. GRADE OSB SHEATHING WITH ICE AND WATER SHIELD ON (1) LAYER OF 30# ROOFING FELT		
	( <u>* con</u>		PROVIDE FULL SCALE MOCK UP PANEL OF	$\langle \square \rangle$	
	(		PROPOSED EXTERIOR FINISH MATERIALS PRIOR TO INSTALLATION	<u>/                                     </u>	
	Y	$\mathcal{N}$		) 🔽	
				DRAWN BY:	: PROJ. MGR:
				SH	
				EXTERI	IOR ELEVATIONS
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				1600	<sup>04</sup> A201
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#### **ELEVATION KEYNOTES** I. 30 YEAR FIBERGLASS SHINGLES 2. PRE-FIN. EXPOSED FASTENER METAL ROOFING EXTERIOR LIGHT FIXTURE (SEE ELECTRICAL DWG'S) KOT HOSTETLER ELECTRICAL METER CENTER (SEE ELEC. DWG'S) 4. ARCHITECTE PRE-FIN. MTL GUTTER AND DOWNSPOUT 5. VINYL CASEMENT WINDOW (JELD-WEN OR EQUAL) 6. 7. ALUM. STOREFRONT SYSTEM (OR ALTERNATE), REFER TO ■ARCHITECTURE ■PLANNING ELEVATIONS SHEET AGO I NOT USED 8. 2906 MARKET STREET, SUITE 101 WILMINGTON, NC 28403 NOT USED 9. PHONE: Shawn - 910.612.1119 10. 5/4 X 8 FIBER CEMENT WALL BAND Greg - 910.612.4364 II. 5/4 X G FIBER CEMENT TRIM www.kot-hostetler.com 12. 5/4 X 10" FIBER CEMENT SKIRT BOARD 13. 5/4 x 6" FIBER CEMENT SKIRT BOARD 14. FIBER CEMENT LAP SIDING WITH 6" EXPOSURE CONSULTANTS 15. IX FIBER CEMENT FASCIA AND MTL. DRIP EDGE 16. 12" CELLULAR PVC COLUMN SURROUND WITH 9 1/4" PVC BASE AND CAPITAL (WHERE SHOWN), (CHADSWORTH - 'SQUARE NON-TAPERED' OR EQUAL) 17. NOT USED 18. SUNSHADE STRUCTURE: P.T. AND RE-DRIED 4X10 BEAM AND WALL STUBS WITH 2X4 HORIZ. LOUVERS (STAIN AND SEAL) 19. EXTERIOR INSULATED MTL DOOR 20. ALUM. DOOR AND FRAME (REFER TO OPENING SCHED. SHT AGO !) 21. APPROX. FINISHED GRADE 22. ALUM. POOL BARRIER FENCE, REFER TO DETAIL 1/A002 23. FIBER CEMENT LAP SIDING WITH 4" EXPOSURE PAINTED ACCENT COLOR 24. 5/4 X 6 FIBER CEMENT WINDOW/DOOR SURROUND TRIM **NEW CLUBHOUSE FOR** 25. 5/4 X 8 FIBER CEMENT RAKE BOARD 26. 5/16" FIBER CEMENT PANEL **EXTERIOR MATERIALS LEGEND** FIBER CEMENT SOFFIT: JAMES HARDIE BUILDING PRODUCTS, INC. MANUF: PRODUCT STYLES: A. VENTED SMOOTH (HARDIESOFFIT) B. NON-VENTED SMOOTH (HARDISOFFIT) **ABBOTTS RUN** C. BEADED PORCH PANEL (HARDIESOFFIT) PROFILE: FACTORY PRIMED, FINISH W/ 100% ACRYLIC EXTERIOR FINISH: PAINT (2 COATS MIN.) **APARTMENTS** COLOR: T.B.D. FASTENERS: PER MANUF. RECOMMENDATIONS FIBER CEMENT SIDING: JAMES HARDIE BUILDING PRODUCTS, INC. MANUF.: PRODUCT: A. HARDIE TRIM BOARDS (SIZE INDICATED ON DRAWINGS) B. 5/16" THICK LAP SIDING W/ 6" EXPOSURE (HARDIPLANK) C. 5/16" PANEL (HARDIPANEL VERTICAL SIDING) FACTORY PRIMED, FINISH W/ 100% ACRYLIC EXTERIOR FINISH WILMINGTON AR HOUSING, PAINT (2 COATS) ER MANUE. BEGOMA LLC CULTURED STONE TILE: COVERALL STONE, INC. MANUF : PRODUCT: STACKED PEBBLE TILE STACKED SEASIDE OCEAN BLEND (PT-ST-OB) FINISH: FASTENERS: PER MANUF. RECOMMENDATIONS WILMINGTON ACCESSORIES: N/A GROUT: GRAY NORTH CAROLINA MORTER BED ON WIRE MESH AND SCRATCH COAT, ON 1/2' SUBSTRATE: CEMENT BOARD (VERIFY WITH MANUF.) ROOF ASSEMBLY DESCRIPTION S FIBERGLASS SHINGLES -ROOFING: GRANULAR SURFACED, FIBERGLASS REINF. ASPHALT SHINGLE AR( MANUF .: GAF MATERIALS CORPORATION TIMBERLINE HD PRODUCT: ETLER REGIS TO BE SELECTED FROM MANUF. FULL LINE COLOR: TRIM: .032 KYNAR COATED ALUMINUM (COLOR T.B.D.) FLASHINGS: .032 KYNAR COATED ALUMINUM (COLOR T.B.D.) ACCESSORIES: PROVIDE STANDARD ACCESSORIES AND ITEMS ESSENTIAL TO COMPLETION OF ROOF INSTALLATION INCLUDING HIP AND RIDGE SHINGLES, RIDGE VENT, CLOSURES, FLASHING, 'T STYLE DRIP EDGE AND FASCIA COLOR COORDINATED PRIMERLESS SILICONE OR HIGH SEALANT: GRADE, NON-DRYING BUTYL AS REQUIRED BY MANUF. 5/8" EXTERIOR GRADE OSB SHEATHING WITH ICE AND WATER SHIELD AT HIPS AND VALLEYS ON (1) LAYER OF 30# ROOFING FELT SUBSTRATE: Ю. AT SLOPES GREATER THAN 4:12, OR (2) LAYERS OF 15# ROOFING FELT AT SLOPES LESS THAN 4:12. 1. PROVIDE ROOF ACCESSORIES AND PENETRATION DETAILS AS REQUIRED BY MANUEACTURER TO MAINTAIN 'GOLDEN PLEDGE' WARRANTY EXPOSED FASTENER METAL PANEL PANEL LENGTH: ONE PIECE SINGLE LENGTH PANEL METAL: .040 ALUM. (COLOR T.B.D.) DEPTH: 1 1/2" .040 ALUM. (COLOR T.B.D.) TRIM: SEAMS: EXPOSED FASTENER INTERLOCKING PANEL WIDTH: MATCH GUAGE AND FINISH OF ROOF PANELS FLASHINGS: **¢ONSTRUCTION DOCUMENTS :** 11.30.16 ACCESSORIES: PROVIDE STANDARD ACCESSORIES AND ITEMS REVISIONS ESSENTIAL TO COMPLETION OF A STANDING SEAM ROOF INSTALLATION INCLUDING ANCHOR CLIPS, TRIM, RIDGE, CLOSURES, FLASHING AND FASCIA DESCRIPTION MARK DATE COLOR COORDINATED PRIMERLESS SILICONE OR HIGH SEALANT: GRADE, NON-DRYING BUTYL AS REQUIRED BY MANUF. 11.30.16 VE REVISIONS SUBSTRATE: 5/8" EXT. GRADE OSB SHEATHING WITH ICE AND WATER SHIELD ON (1) LAYER OF 30# ROOFING FELT \*CONTRACTOR NOTE: PROVIDE FULL SCALE MOCK UP PANEL OF PROPOSED EXTERIOR FINISH MATERIALS PRIOR TO INSTALLATION DRAWN BY: PROJ. MGR: SHEET CONTENT EXTERIOR ELEVATIONS JOB NO. SHEET A202 16004
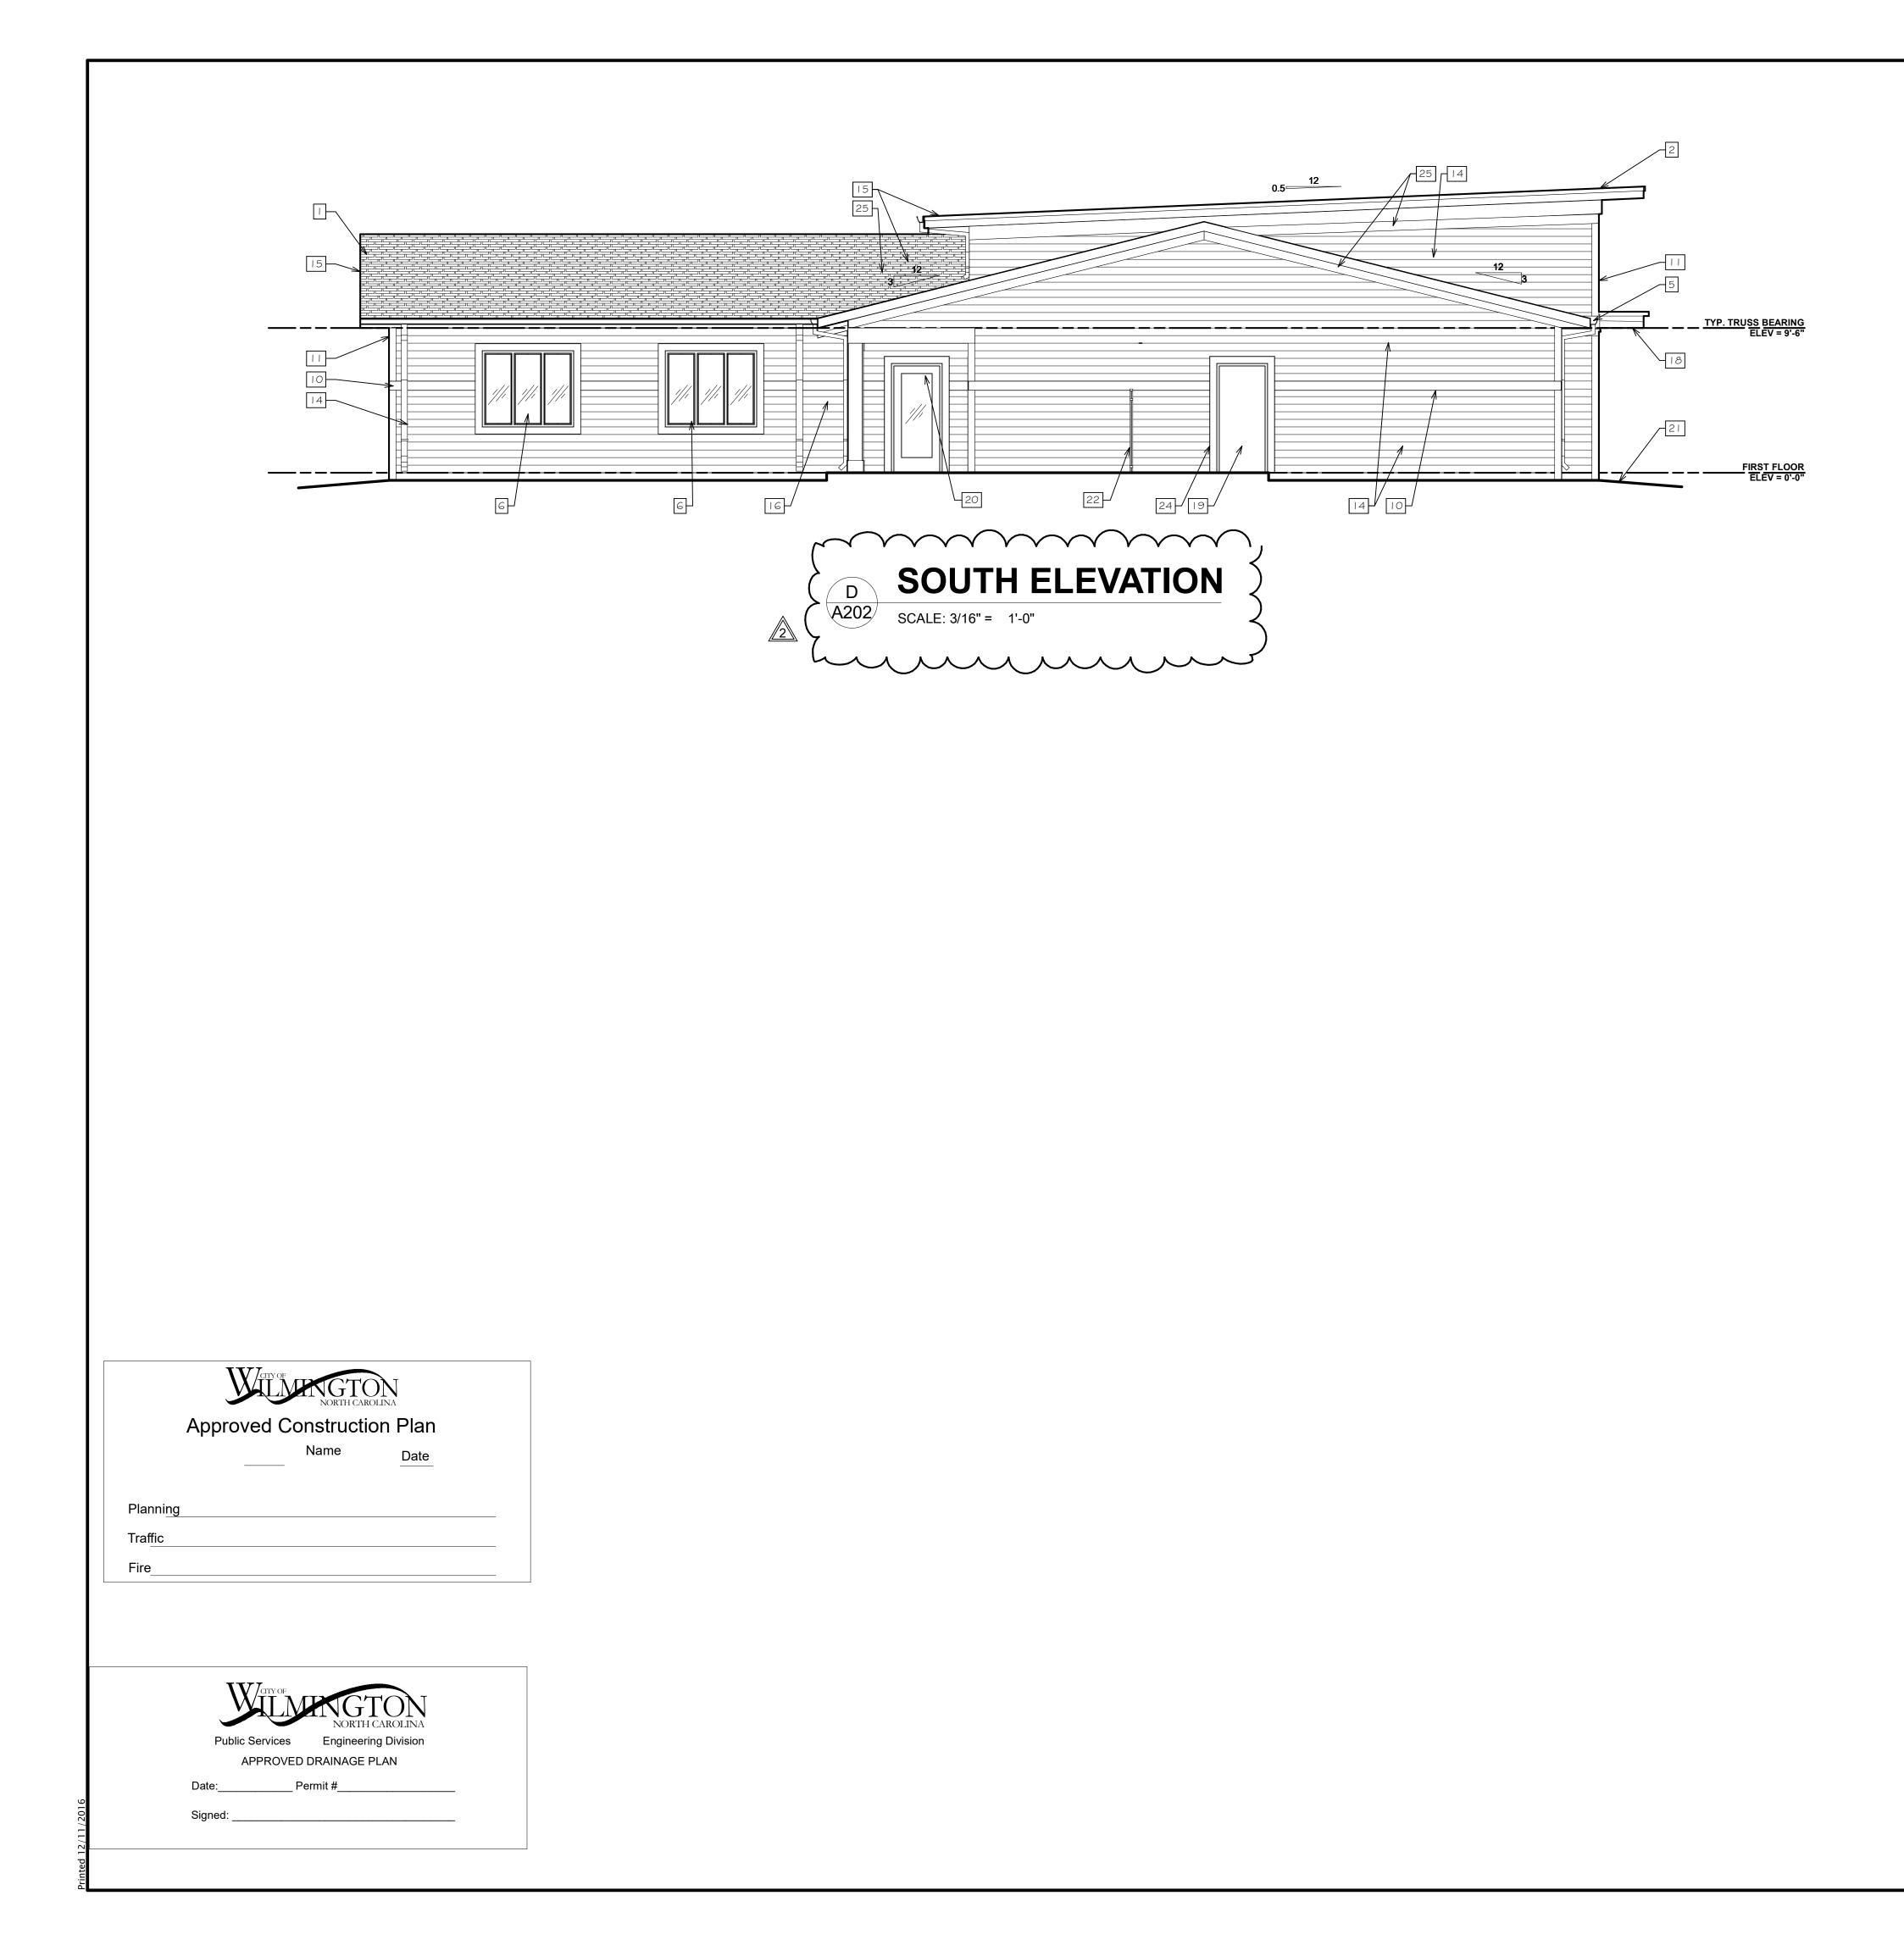
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